
SCONSET BEACH PRESERVATION FUND

SCONSET BLUFF EROSION CONTROL PROJECT NOTICE OF INTENT

DRAWING LIST

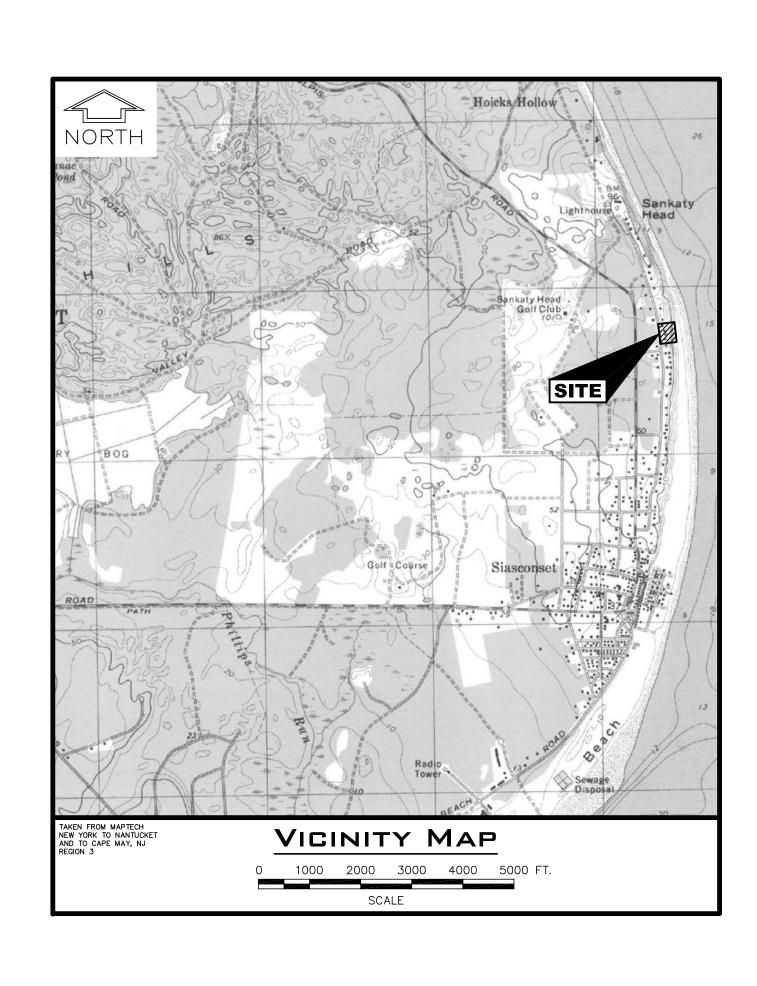

DWG. No.

210019.1-3-01 210019.1-3-02 210019.1-3-03 210019.1-3-04 210019.1-3-05 210019.1-3-06 210019.1-3-07 210019.1-3-08 210019.1-3-09 210019.1-3-10 210019.1-3-11 210019.1-3-12 210019.1-3-13 210019.1-3-14 210019.1-3-15 210019.1-3-16

TITLE

COVER SHEET AND DRAWING LIST EXISTING SITE PLAN - SHEET 1 OF 4 EXISTING SITE PLAN - SHEET 2 OF 4 EXISTING SITE PLAN - SHEET 3 OF 4 EXISTING SITE PLAN - SHEET 4 OF 4 PROPOSED SITE PLAN - SHEET 1 OF 4 PROPOSED SITE PLAN - SHEET 2 OF 4 PROPOSED SITE PLAN - SHEET 3 OF 4 PROPOSED SITE PLAN - SHEET 4 OF 4 PROPOSED SECTION A-A AT LOT 115 PROPOSED SECTION B-B AT LOT 107 PROPOSED SECTION C-C AT LOT 97 PROPOSED SECTION D-D AT LOT 87 PROPOSED SECTION E-E AT LOT 83 PROPOSED SECTION F-F AT LOT 79 PROPOSED SECTION G-G AT LOT 65

REV. No.

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REVISIONS	DESCRIPTION		DATE	BY	DESCRIPTION		DATE	BY	
	1	REVISED DRAWING LIST	8/14/13	BRJ0					
	2	REVISED REVISION LIST	8/23/13	BRJ0					
	3	REVISED REVISION NUMBERS	8/27/13	AZSL					

Ocean and Coastal COVI


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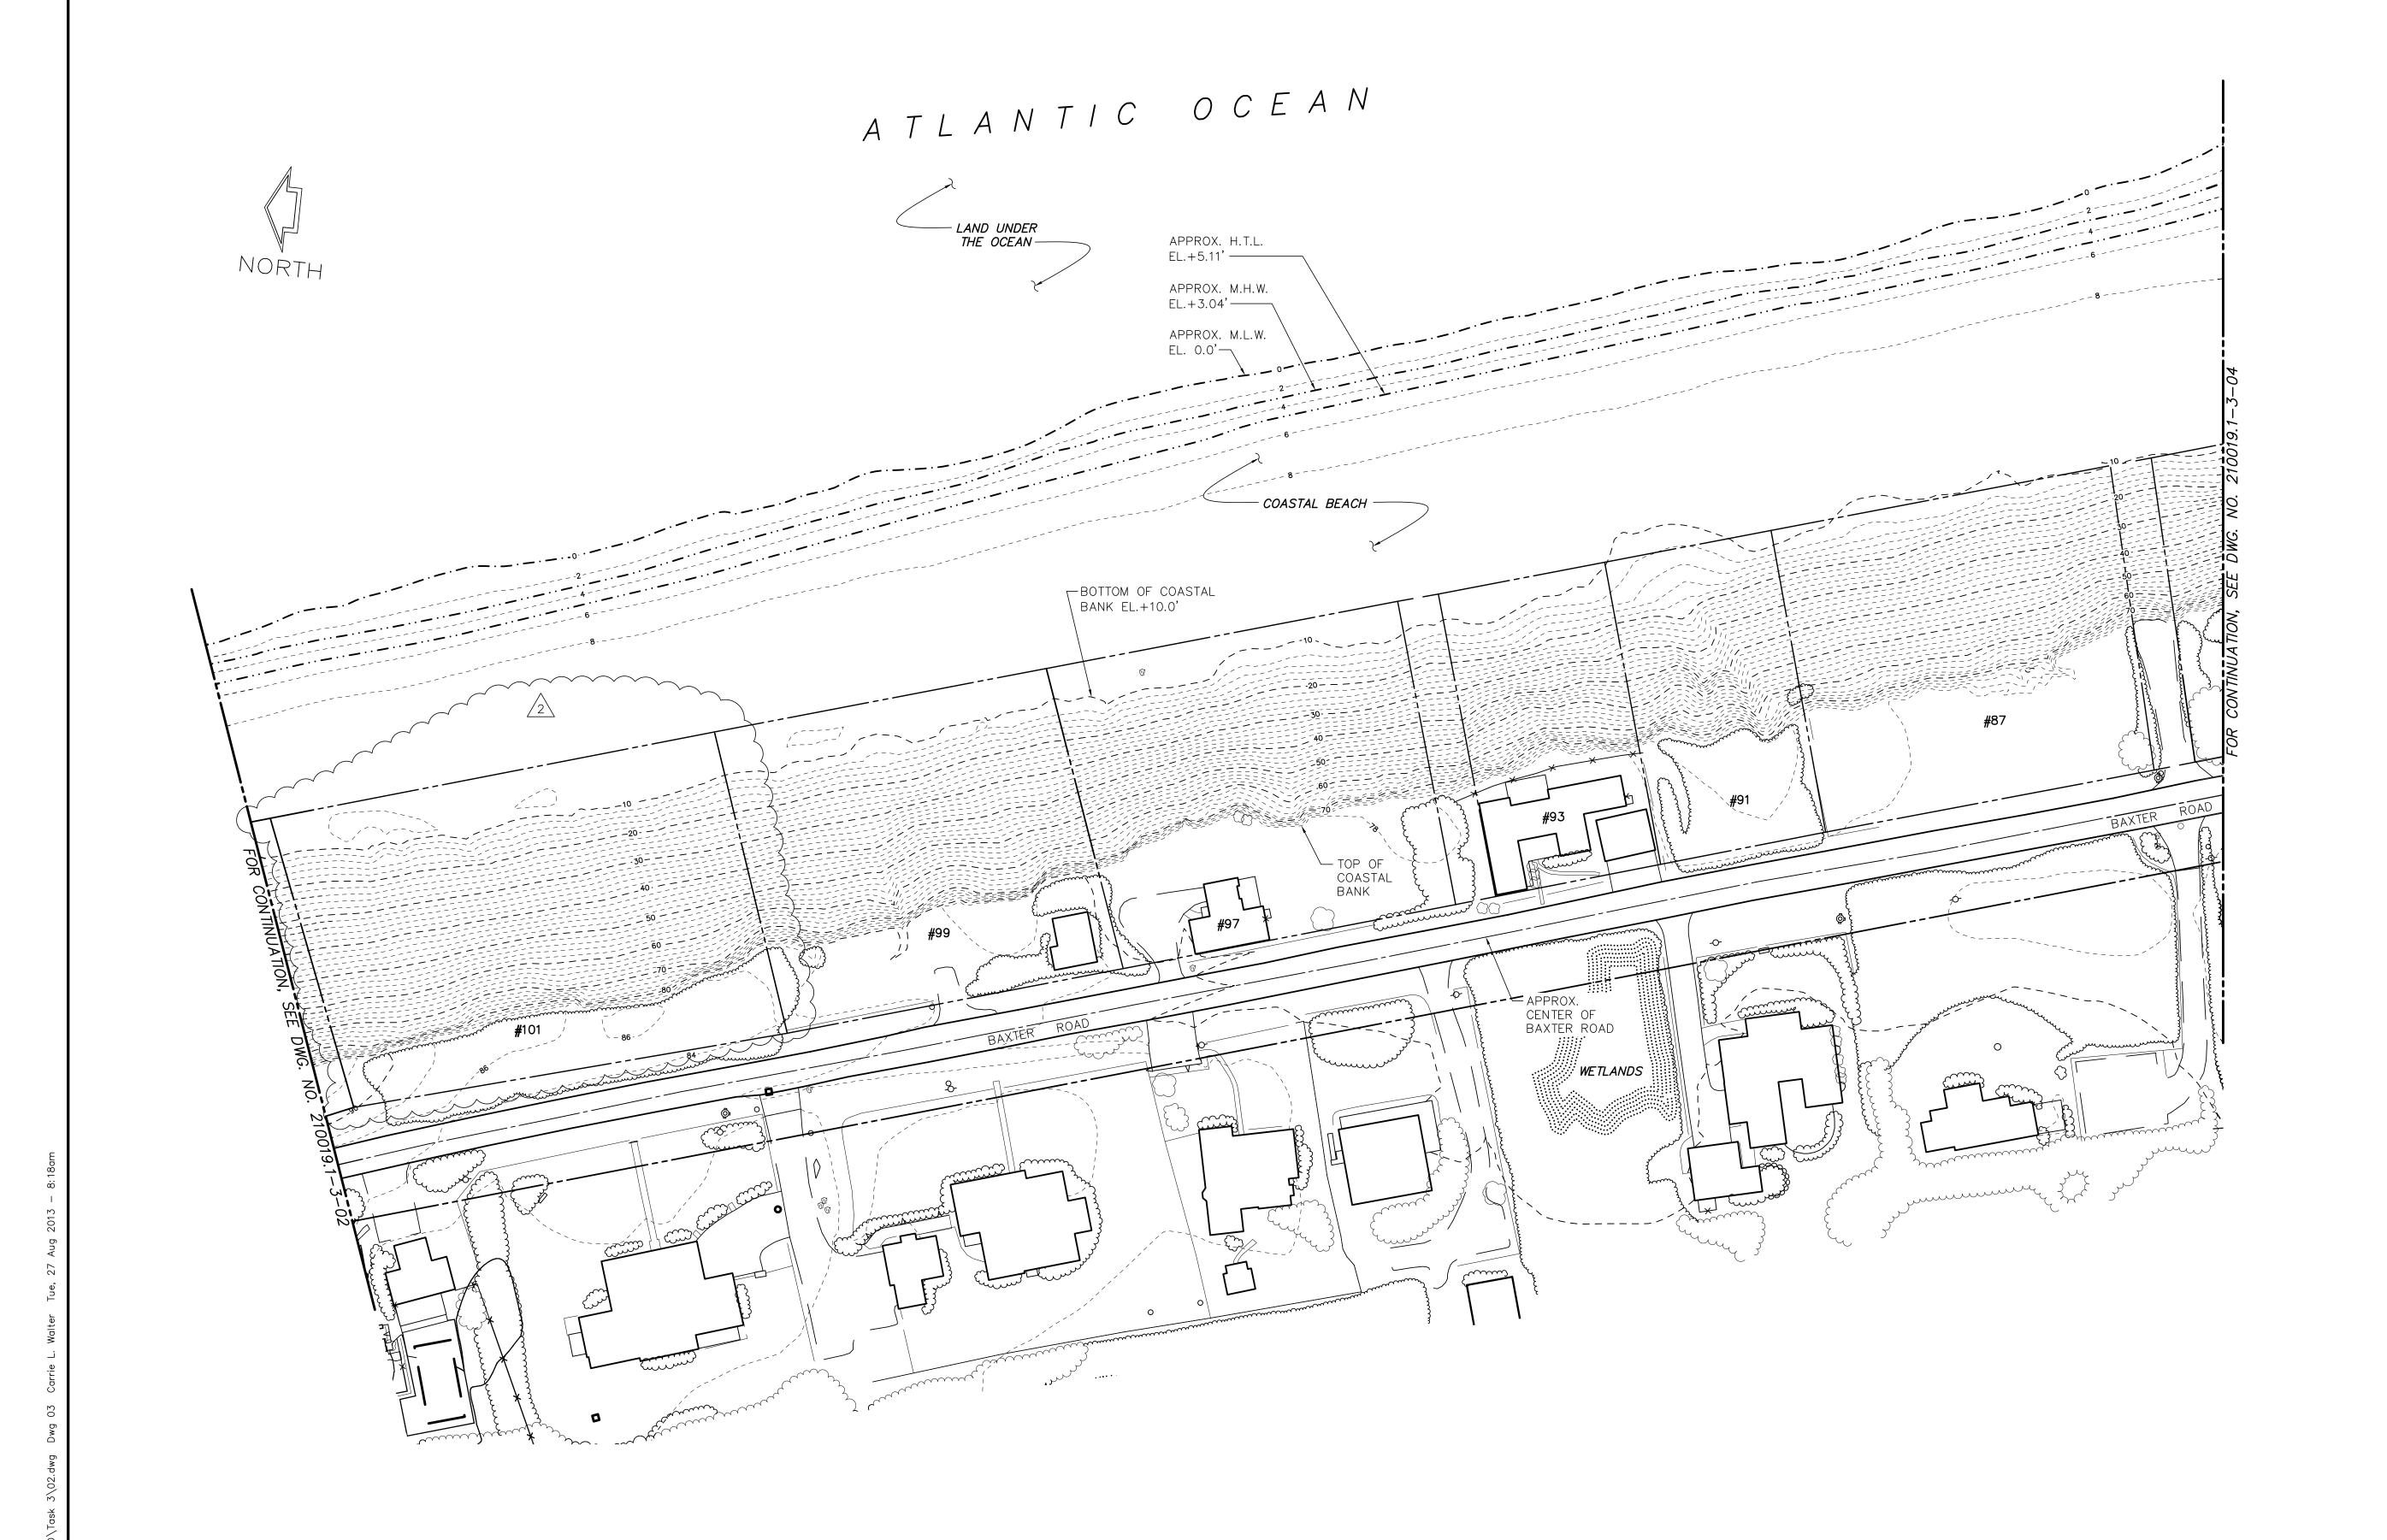
SCONSET BEACH PRESERVATION FUND

18 Sesapana Road, Nantucket, MA 02554

DESIGNED BY: ADKA	SCONSET BLUFF EROSION CONTROL PROJECT
DRAWN BY:	NOTICE OF INTENT
CAMA	THE HELD OF HATELAN
CHECKED BY:	
AZSL	
QC REVIEW:	COVED CHEET AND DRAWING LICT
JOMA	COVER SHEET AND DRAWING LIST

AS NOTED DATE 6/28/13 DRAWING NO.



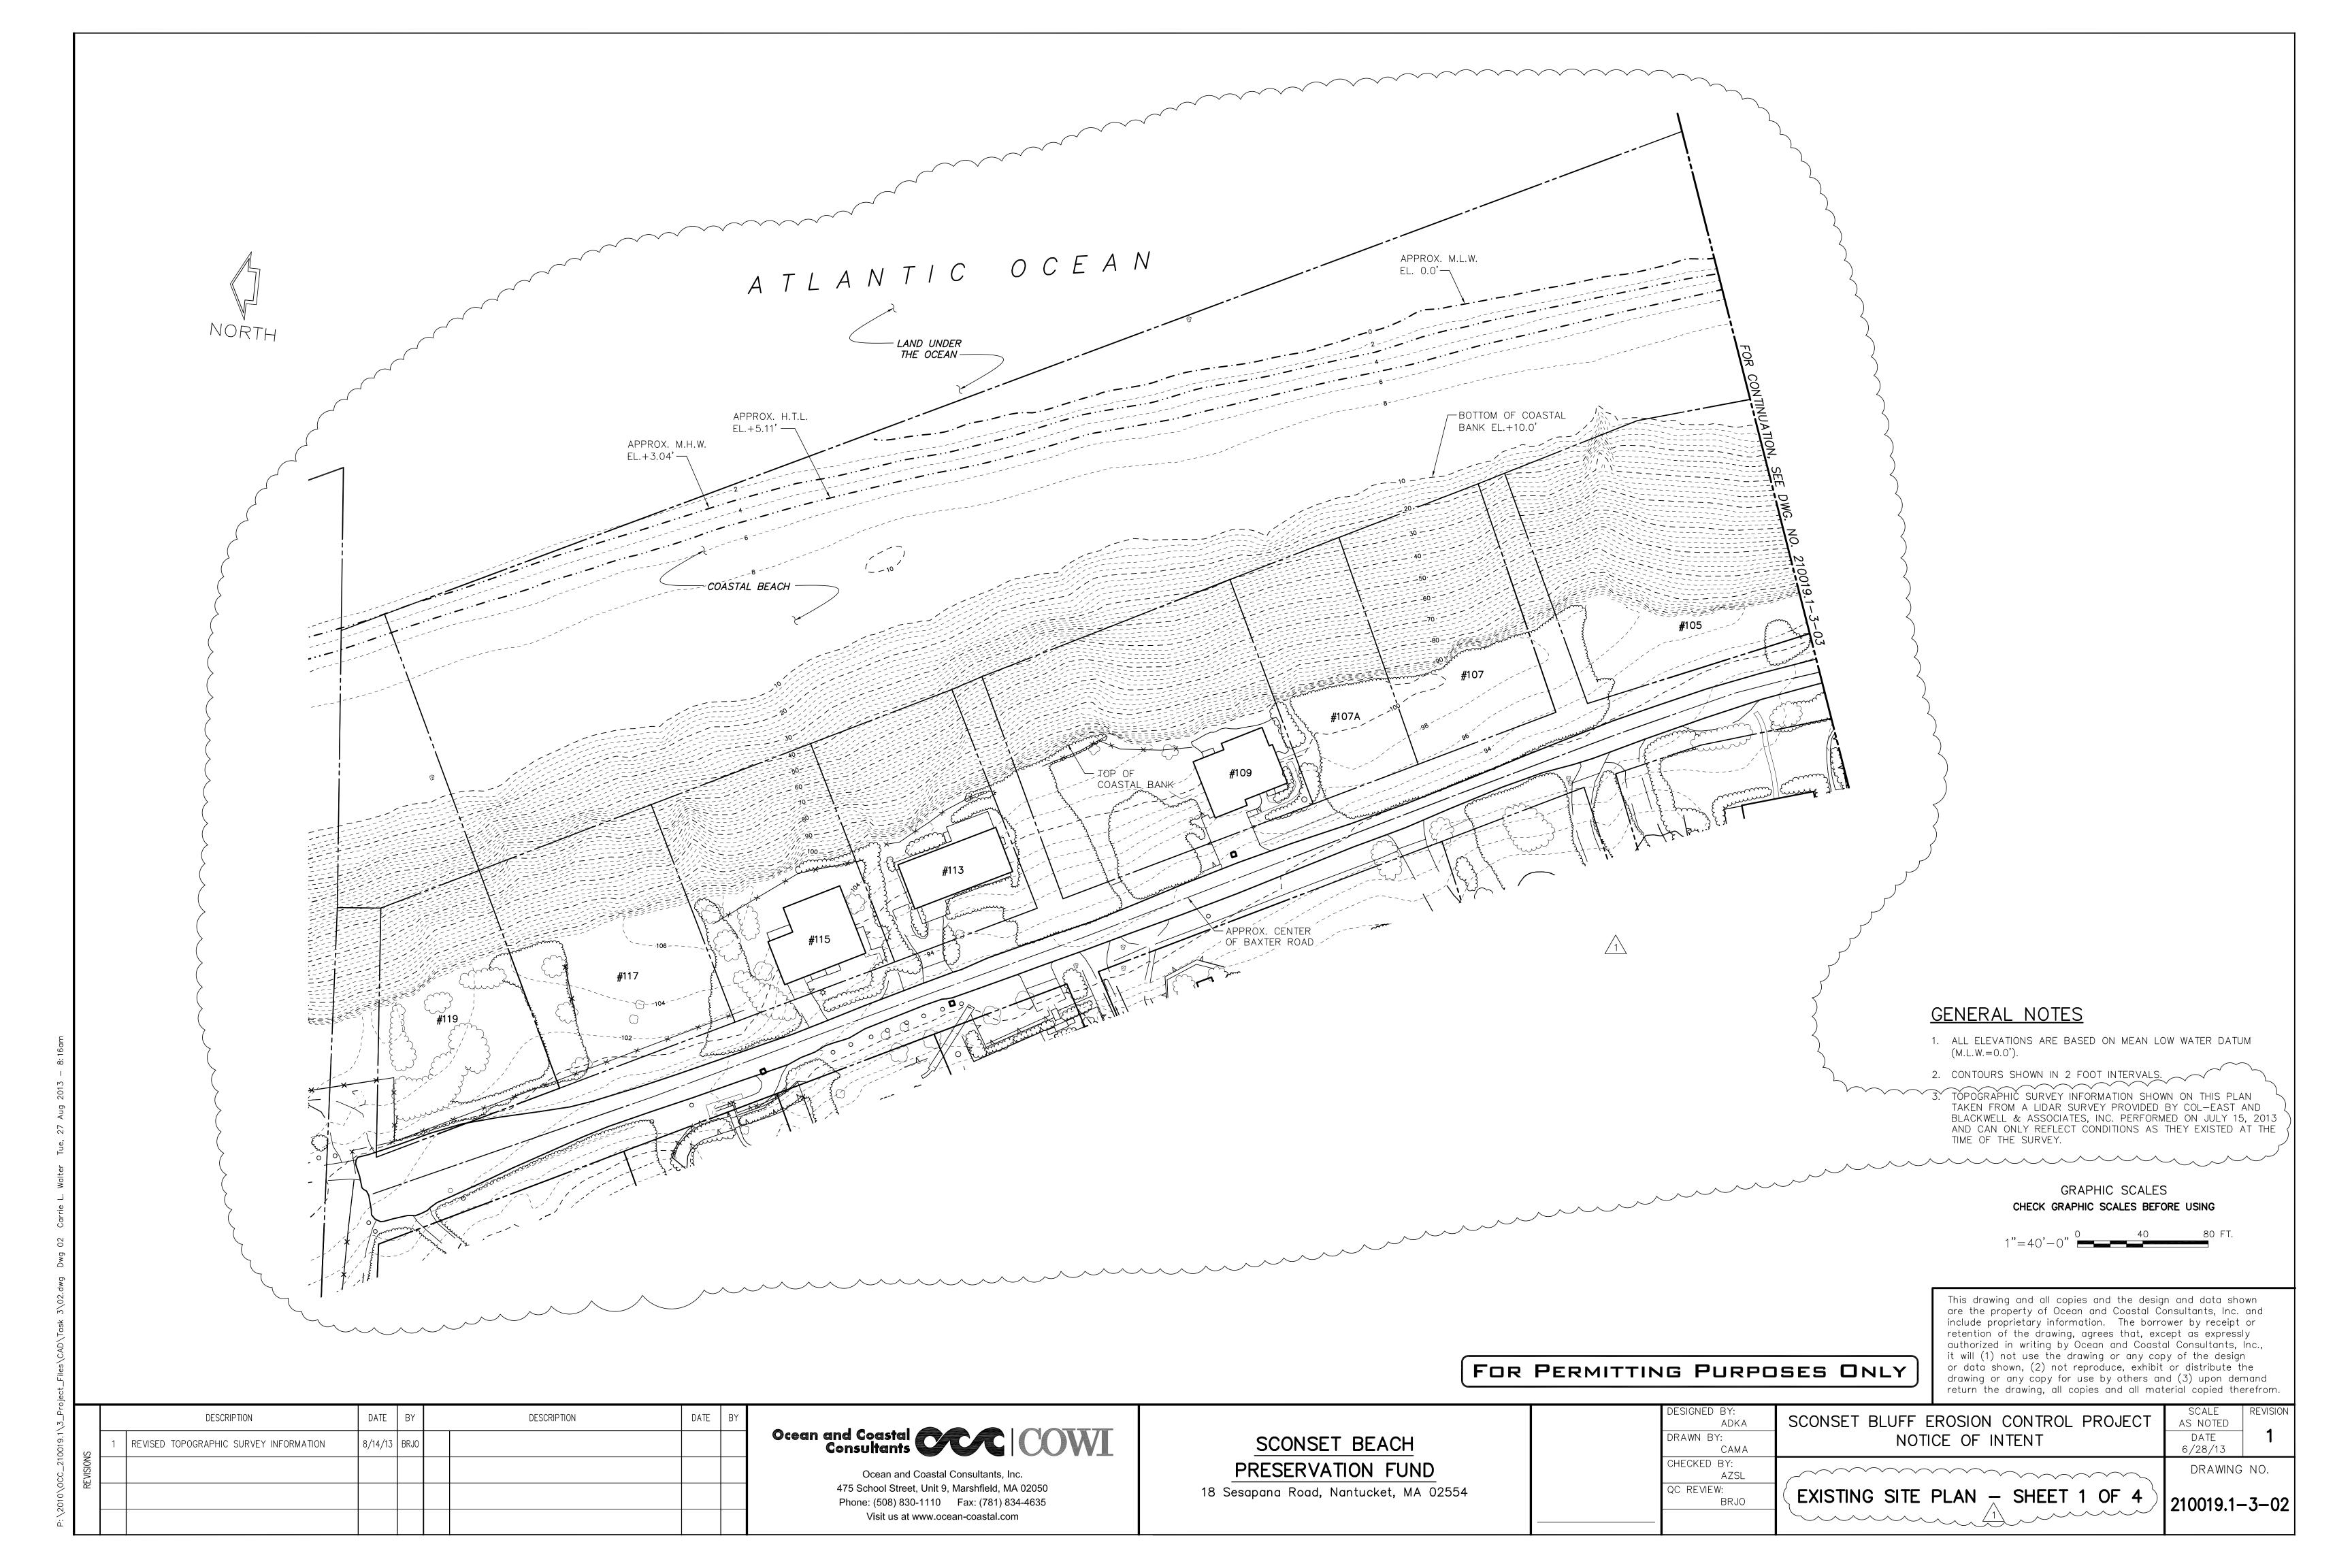

- 1. ALL ELEVATIONS ARE BASED ON MEAN LOW WATER DATUM (M.L.W.=0.0').
- 2. CONTOURS SHOWN IN 2 FOOT INTERVALS.
- 3. TOPOGRAPHIC SURVEY INFORMATION SHOWN ON THIS PLAN TAKEN FROM A LIDAR SURVEY PROVIDED BY COL—EAST AND BLACKWELL & ASSOCIATES, INC. PERFORMED ON JULY 15, 2013 AND CAN ONLY REFLECT CONDITIONS AS THEY EXISTED AT THE TIME OF THE SURVEY.

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DATE BY DESCRIPTION DATE BY DESCRIPTION 8/14/13 BRJO REVISED TOPOGRAPHIC SURVEY INFORMATION ADDED PROPERTY LINE 8/27/13 AZSL

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SCONSET BEACH PRESERVATION FUND

18 Sesapana Road, Nantucket, MA 02554

DESIGNED BY: ADKA DRAWN BY: CAMA	SCONSET BLUFF EROSION CONTROL PROJECT NOTICE OF INTENT
CHECKED BY: AZSL	
QC REVIEW: BRJO	EXISTING SITE PLAN - SHEET 2 OF 4


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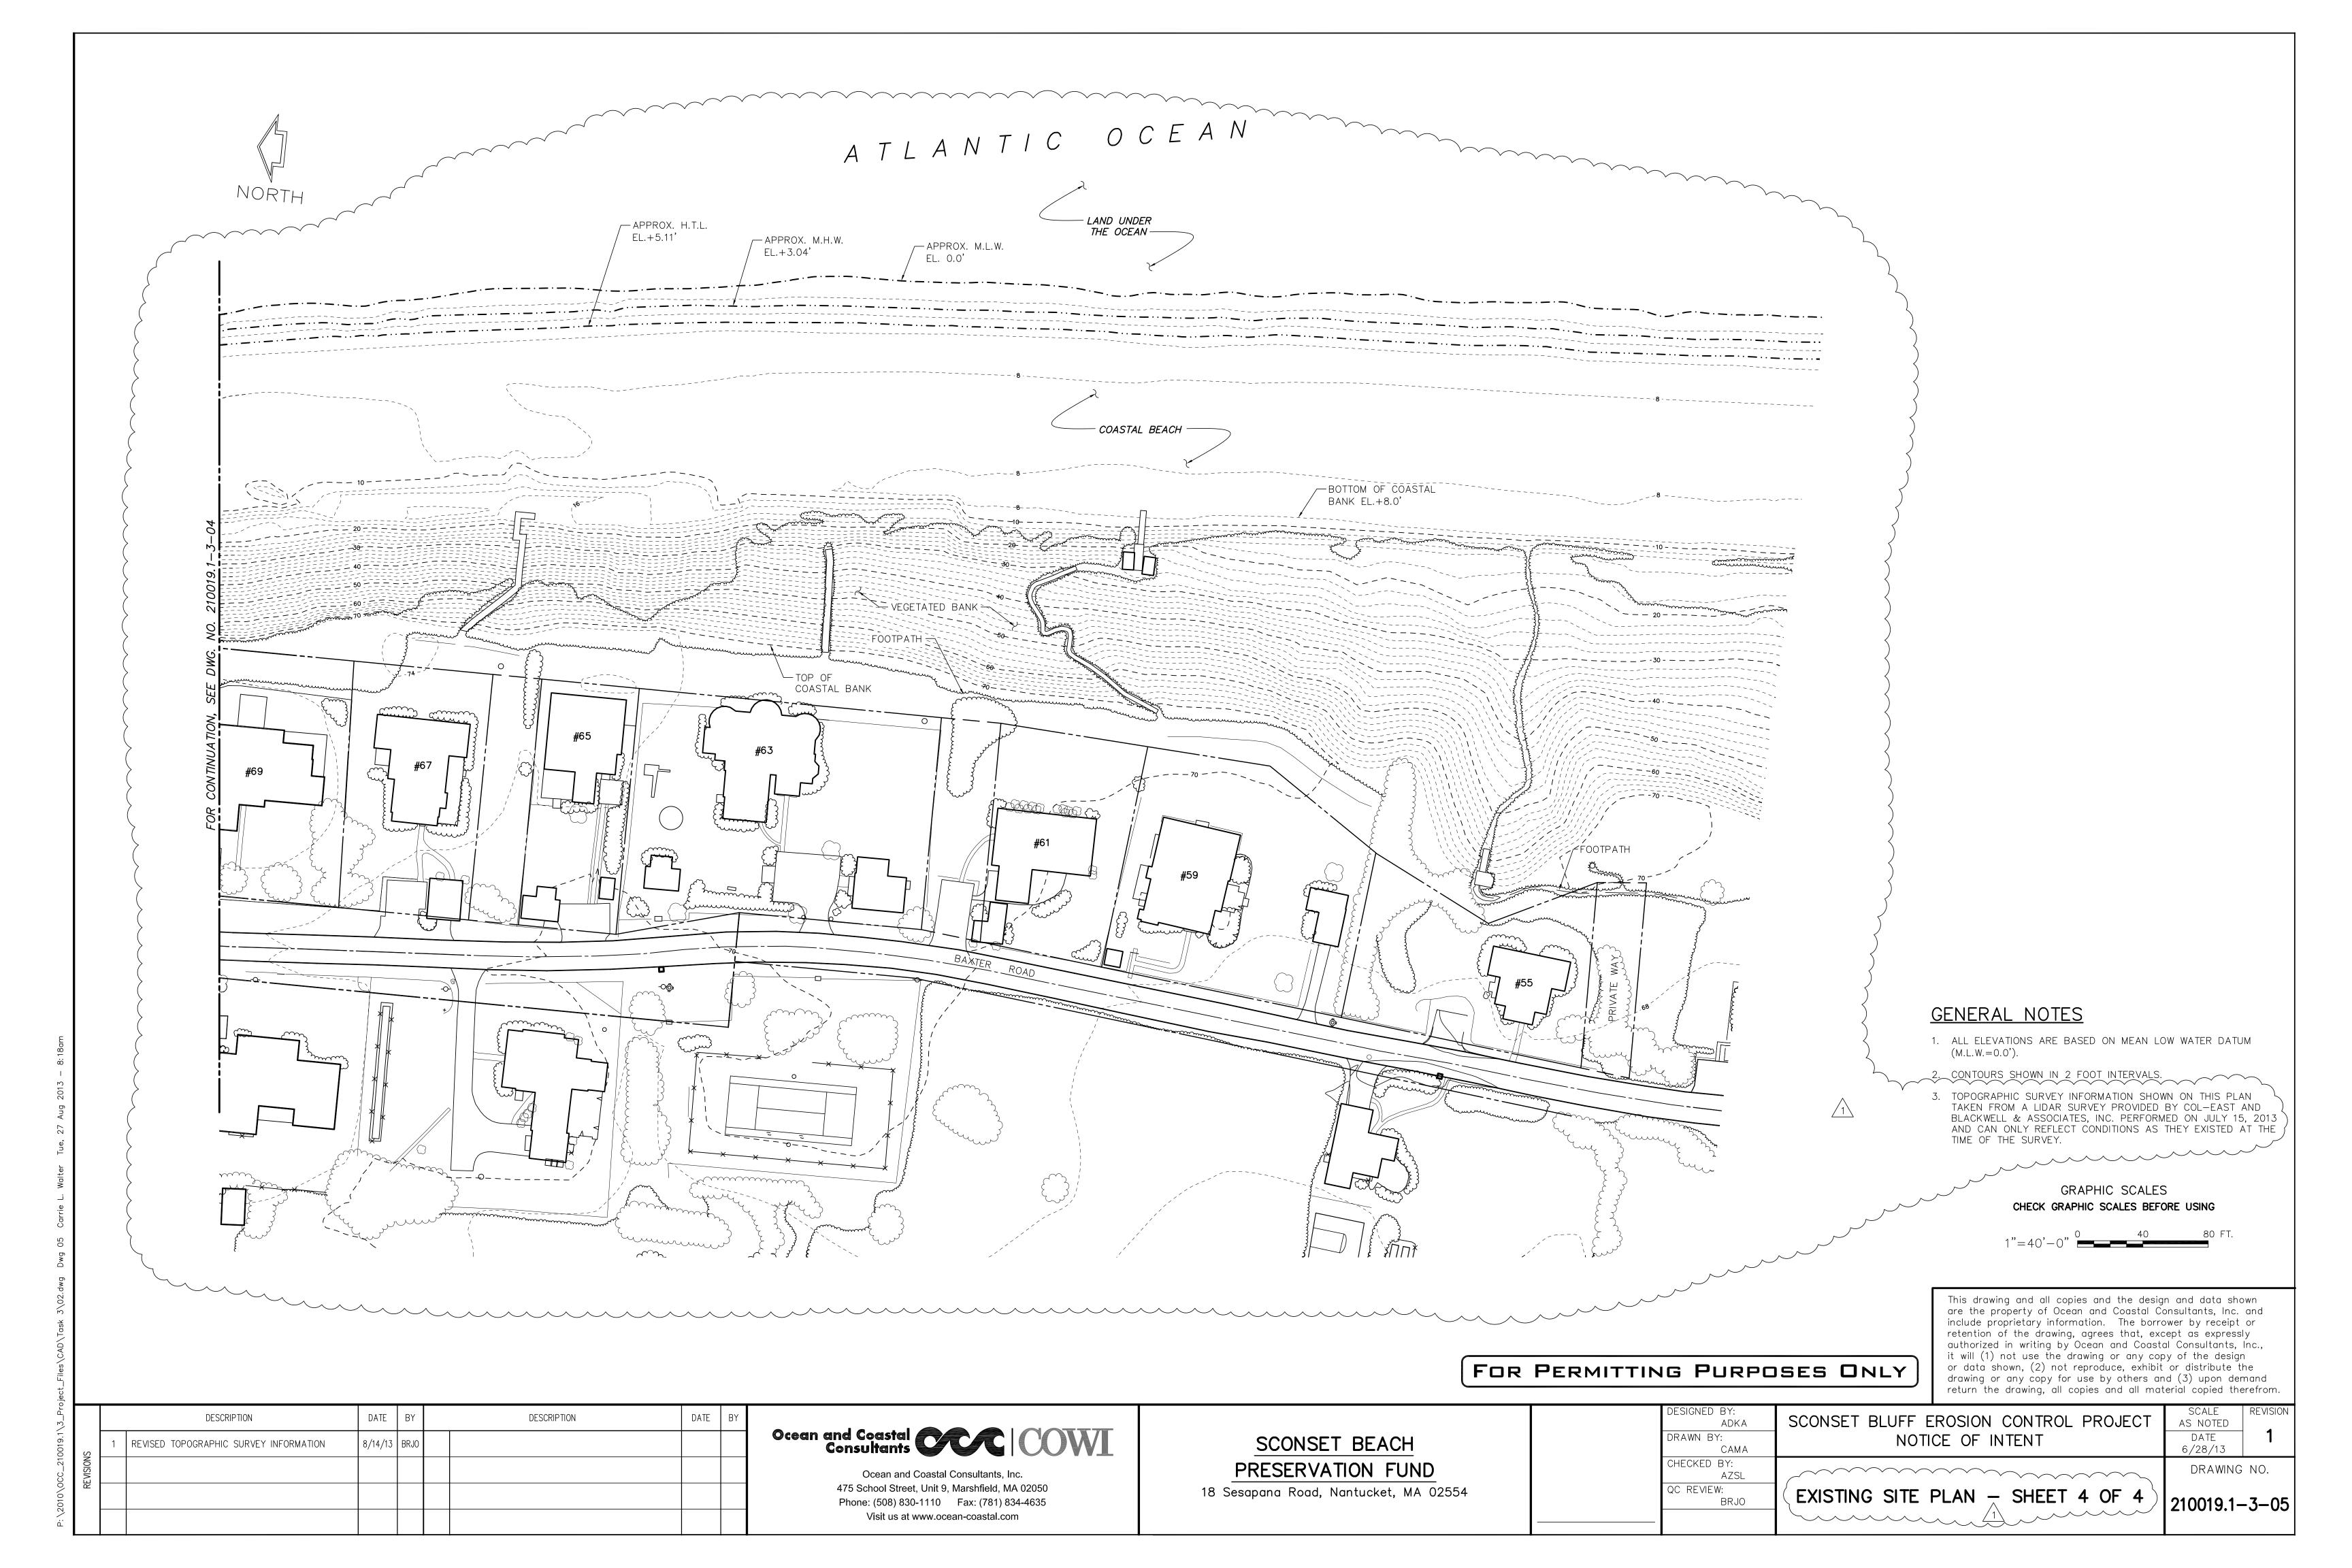
DRAWING NO.


SCALE AS NOTED

DATE

6/28/13



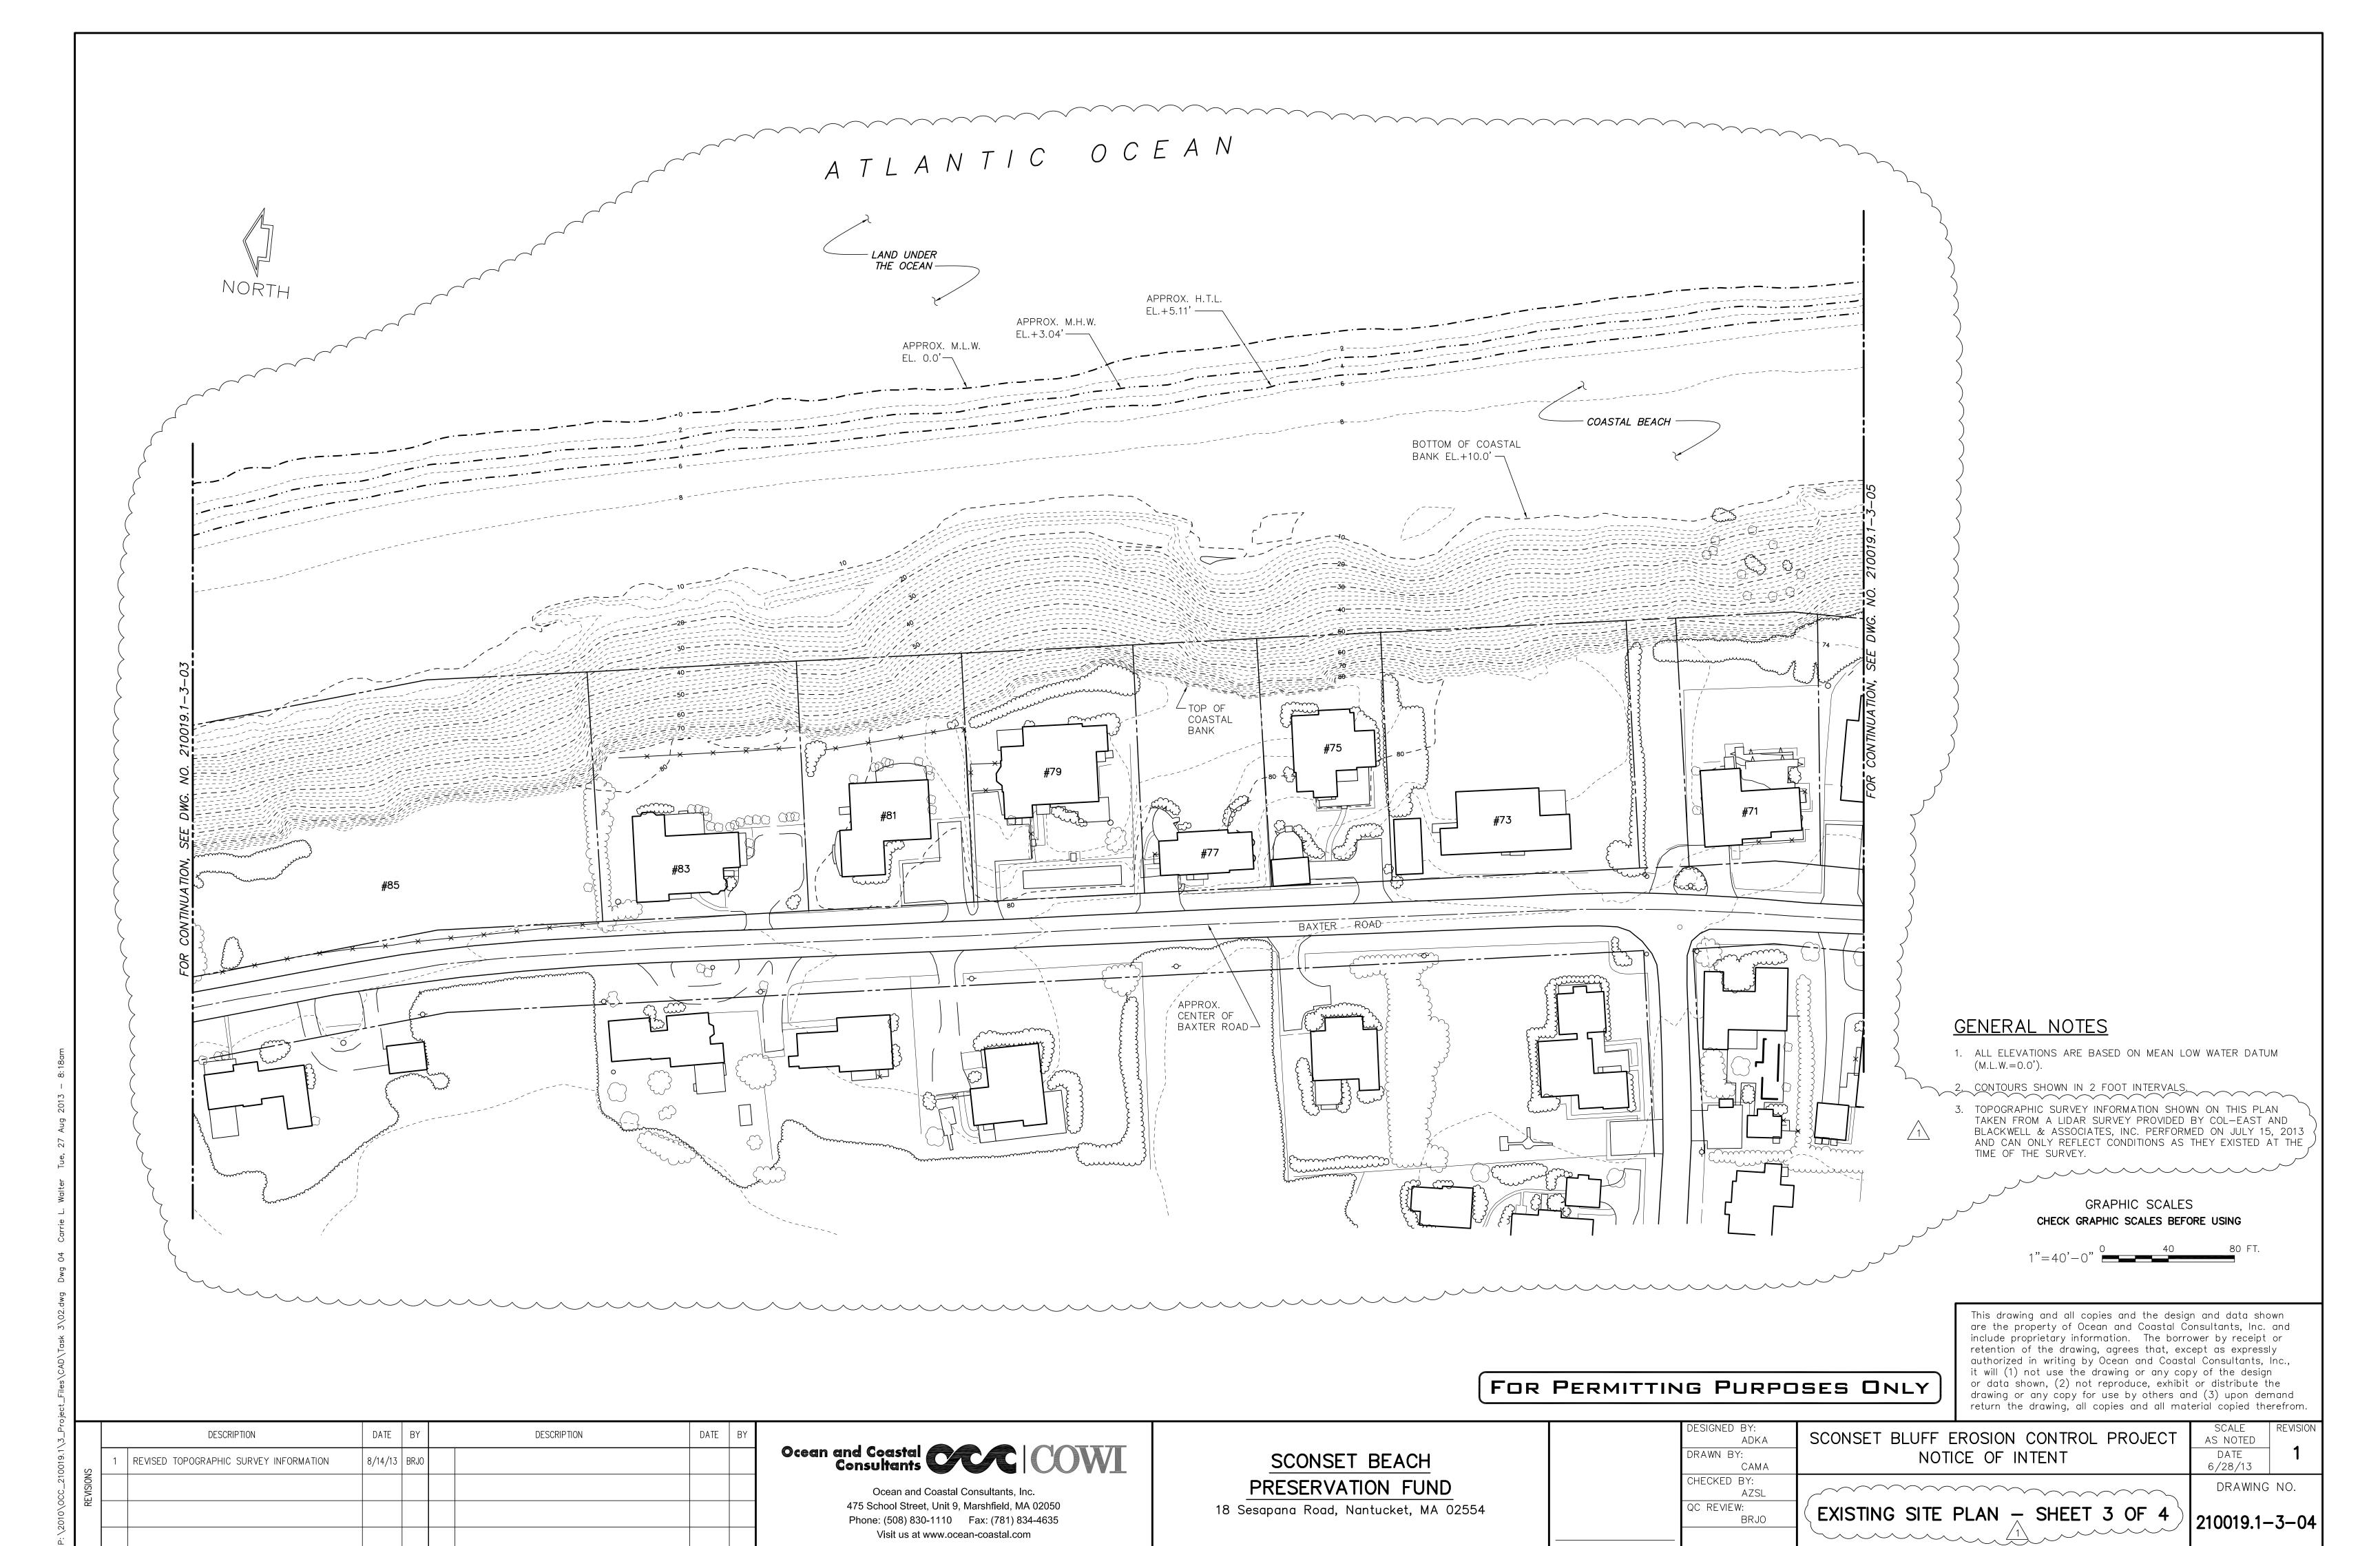

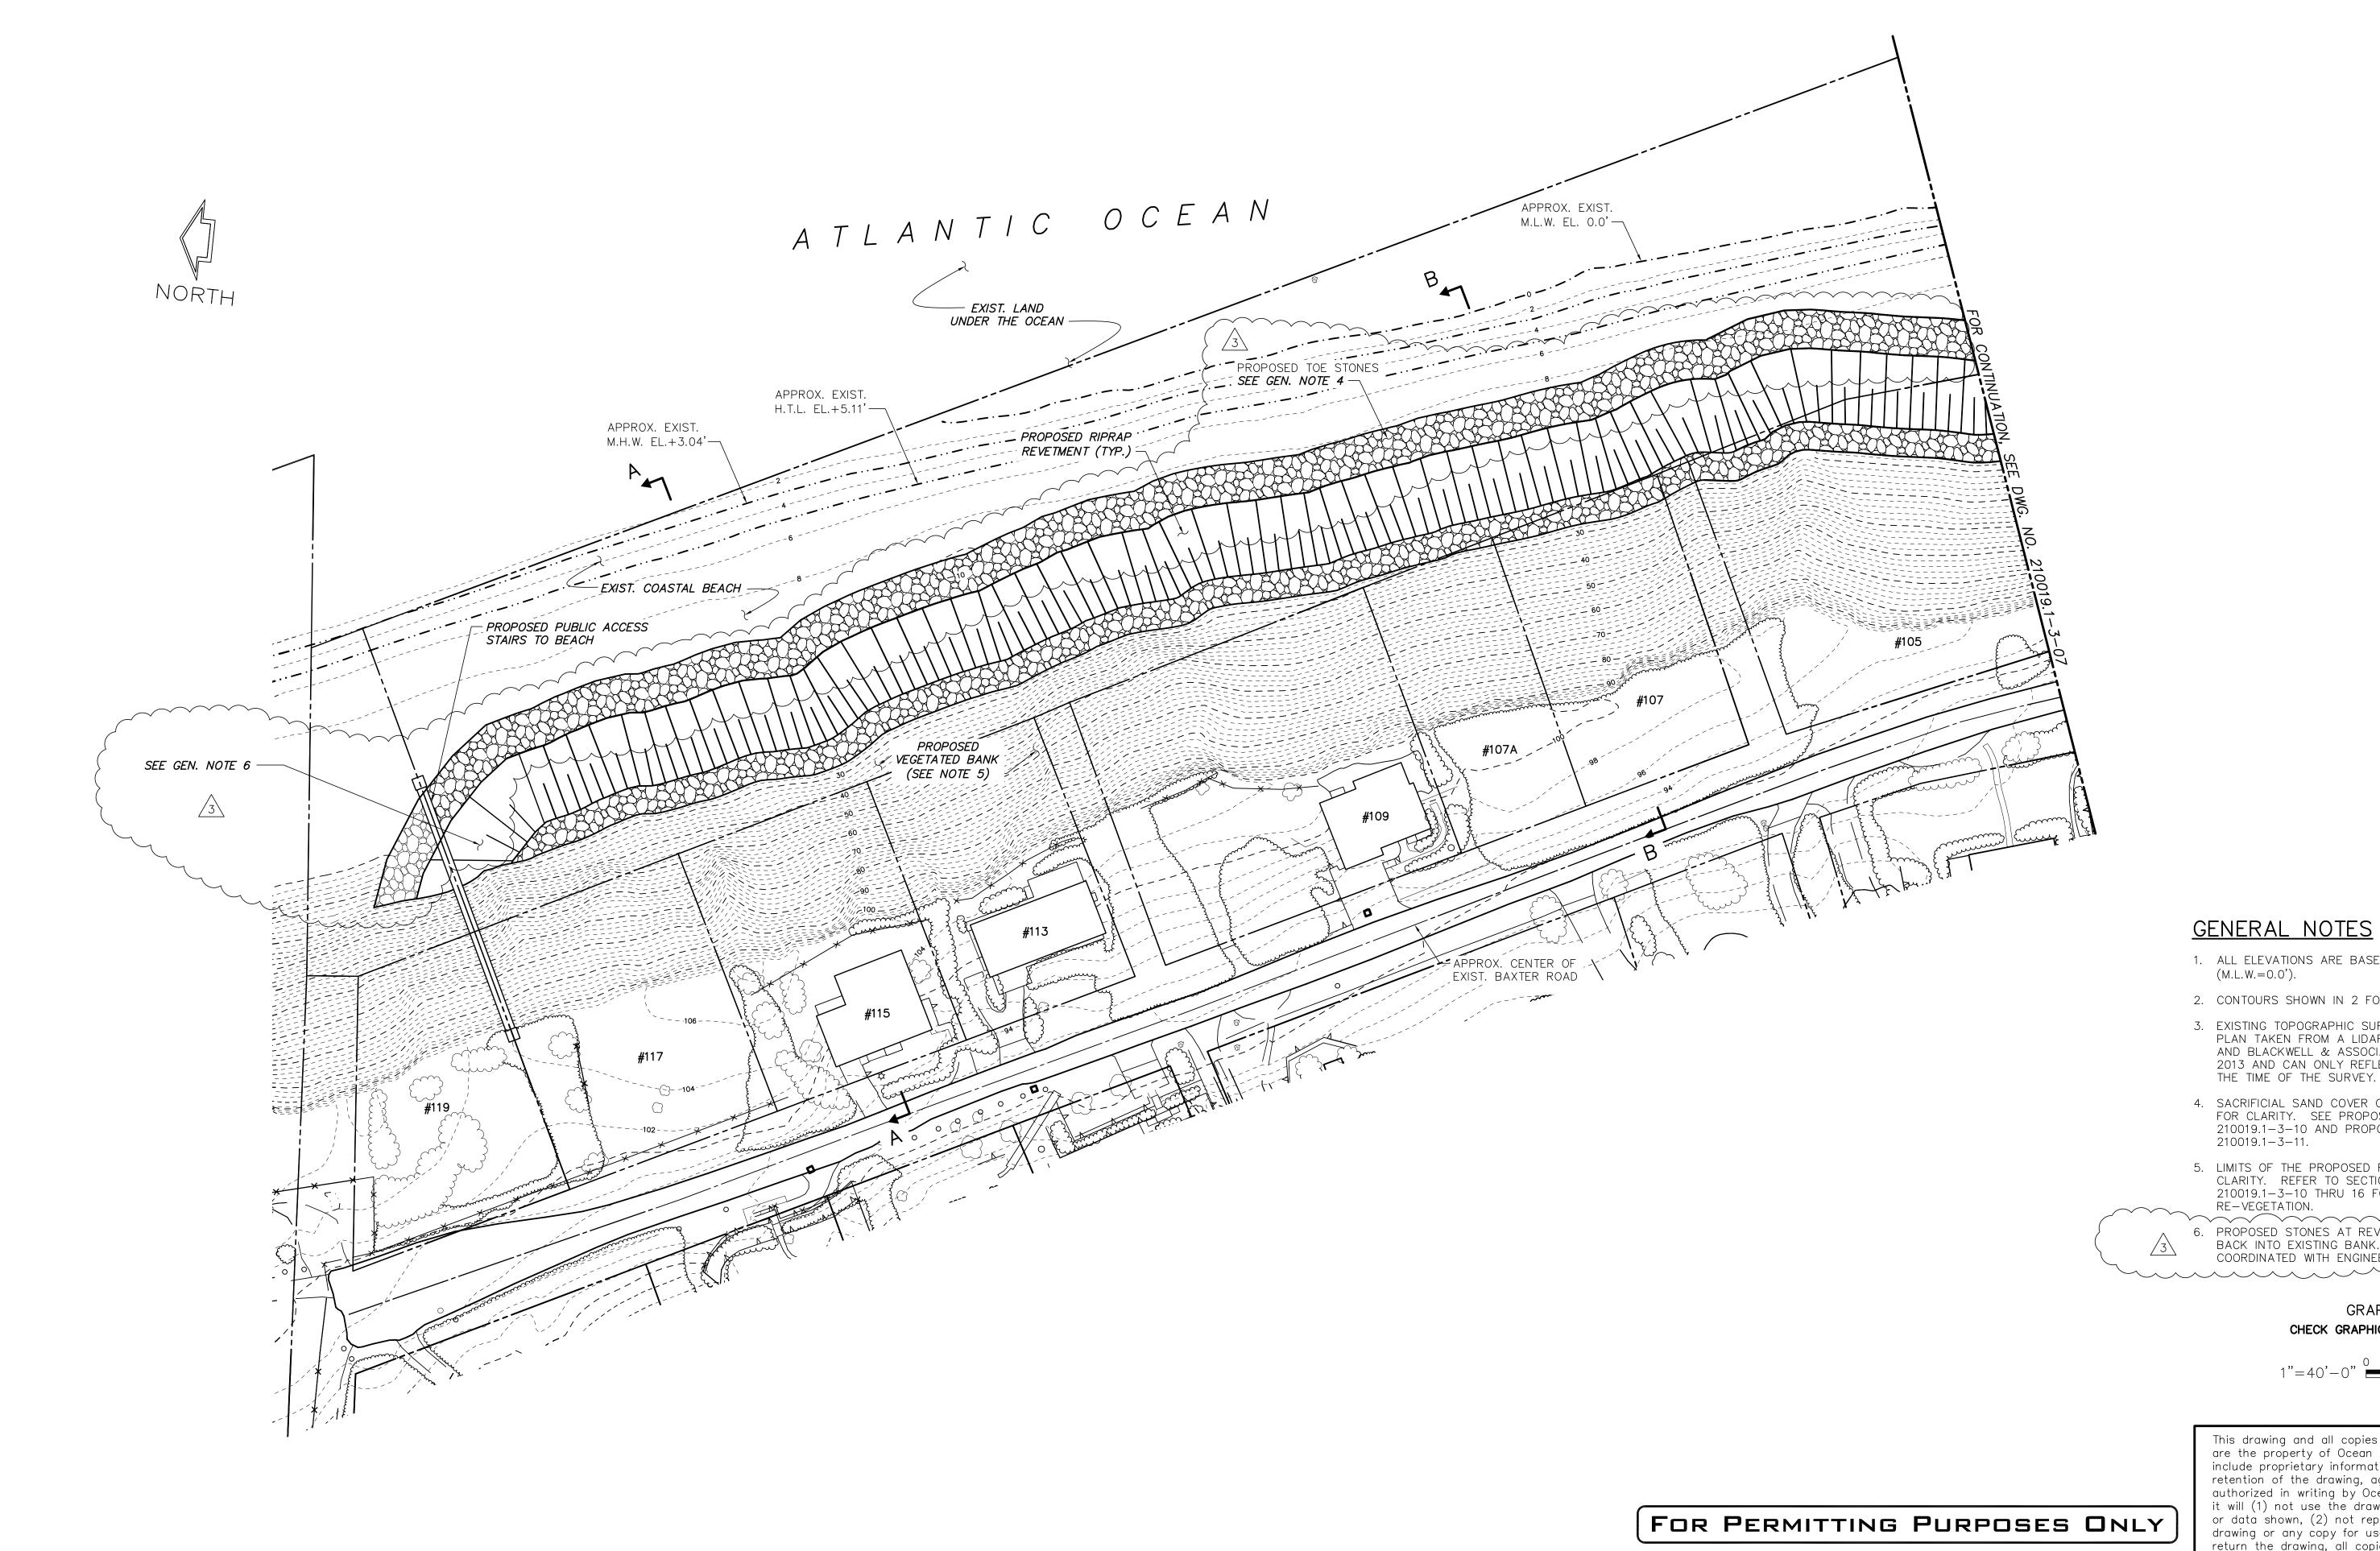

- 1. ALL ELEVATIONS ARE BASED ON MEAN LOW WATER DATUM (M.L.W.=0.0').
- 2. CONTOURS SHOWN IN 2 FOOT INTERVALS.
- 3. EXISTING TOPOGRAPHIC SURVEY INFORMATION SHOWN ON THIS PLAN TAKEN FROM A LIDAR SURVEY PROVIDED BY COL-EAST AND BLACKWELL & ASSOCIATES, INC. PERFORMED ON JULY 15, 2013 AND CAN ONLY REFLECT CONDITIONS AS THEY EXISTED AT THE TIME OF THE SURVEY.
- 4. SACRIFICIAL SAND COVER OVER THE REVETMENT NOT SHOWN FOR CLARITY. SEE PROPOSED SECTION A-A ON DWG. NO. 210019.1-3-10 AND PROPOSED SECTION B-B ON DWG. NO. 210019.1-3-11.
- 5. LIMITS OF THE PROPOSED RE-VEGETATION NOT SHOWN FOR CLARITY. REFER TO SECTION DRAWINGS ON DWG. NOS. 210019.1-3-10 THRU 16 FOR THE EXTENTS OF PROPOSED RE-VEGETATION.
- 6. PROPOSED STONES AT REVETMENT TERMINUS TO BE TAPERED

BACK INTO EXISTING BANK. PLACEMENT AT ENDS TO BE FIELD COORDINATED WITH ENGINEER.

> GRAPHIC SCALES CHECK GRAPHIC SCALES BEFORE USING

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	DESCRIPTION		DATE	BY	DESCRIPTION	DATE	BY
S	1	REVISED TOPOGRAPHIC SURVEY INFORMATION	8/14/13	BRJO			
EVISIONS	2	REVISED SLOPE PROTECTION DESIGN	8/23/13	BRJO			
RE	3	ADDED GENERAL NOTE 6; REVISED REVETMENT	8/27/13	AZSL			

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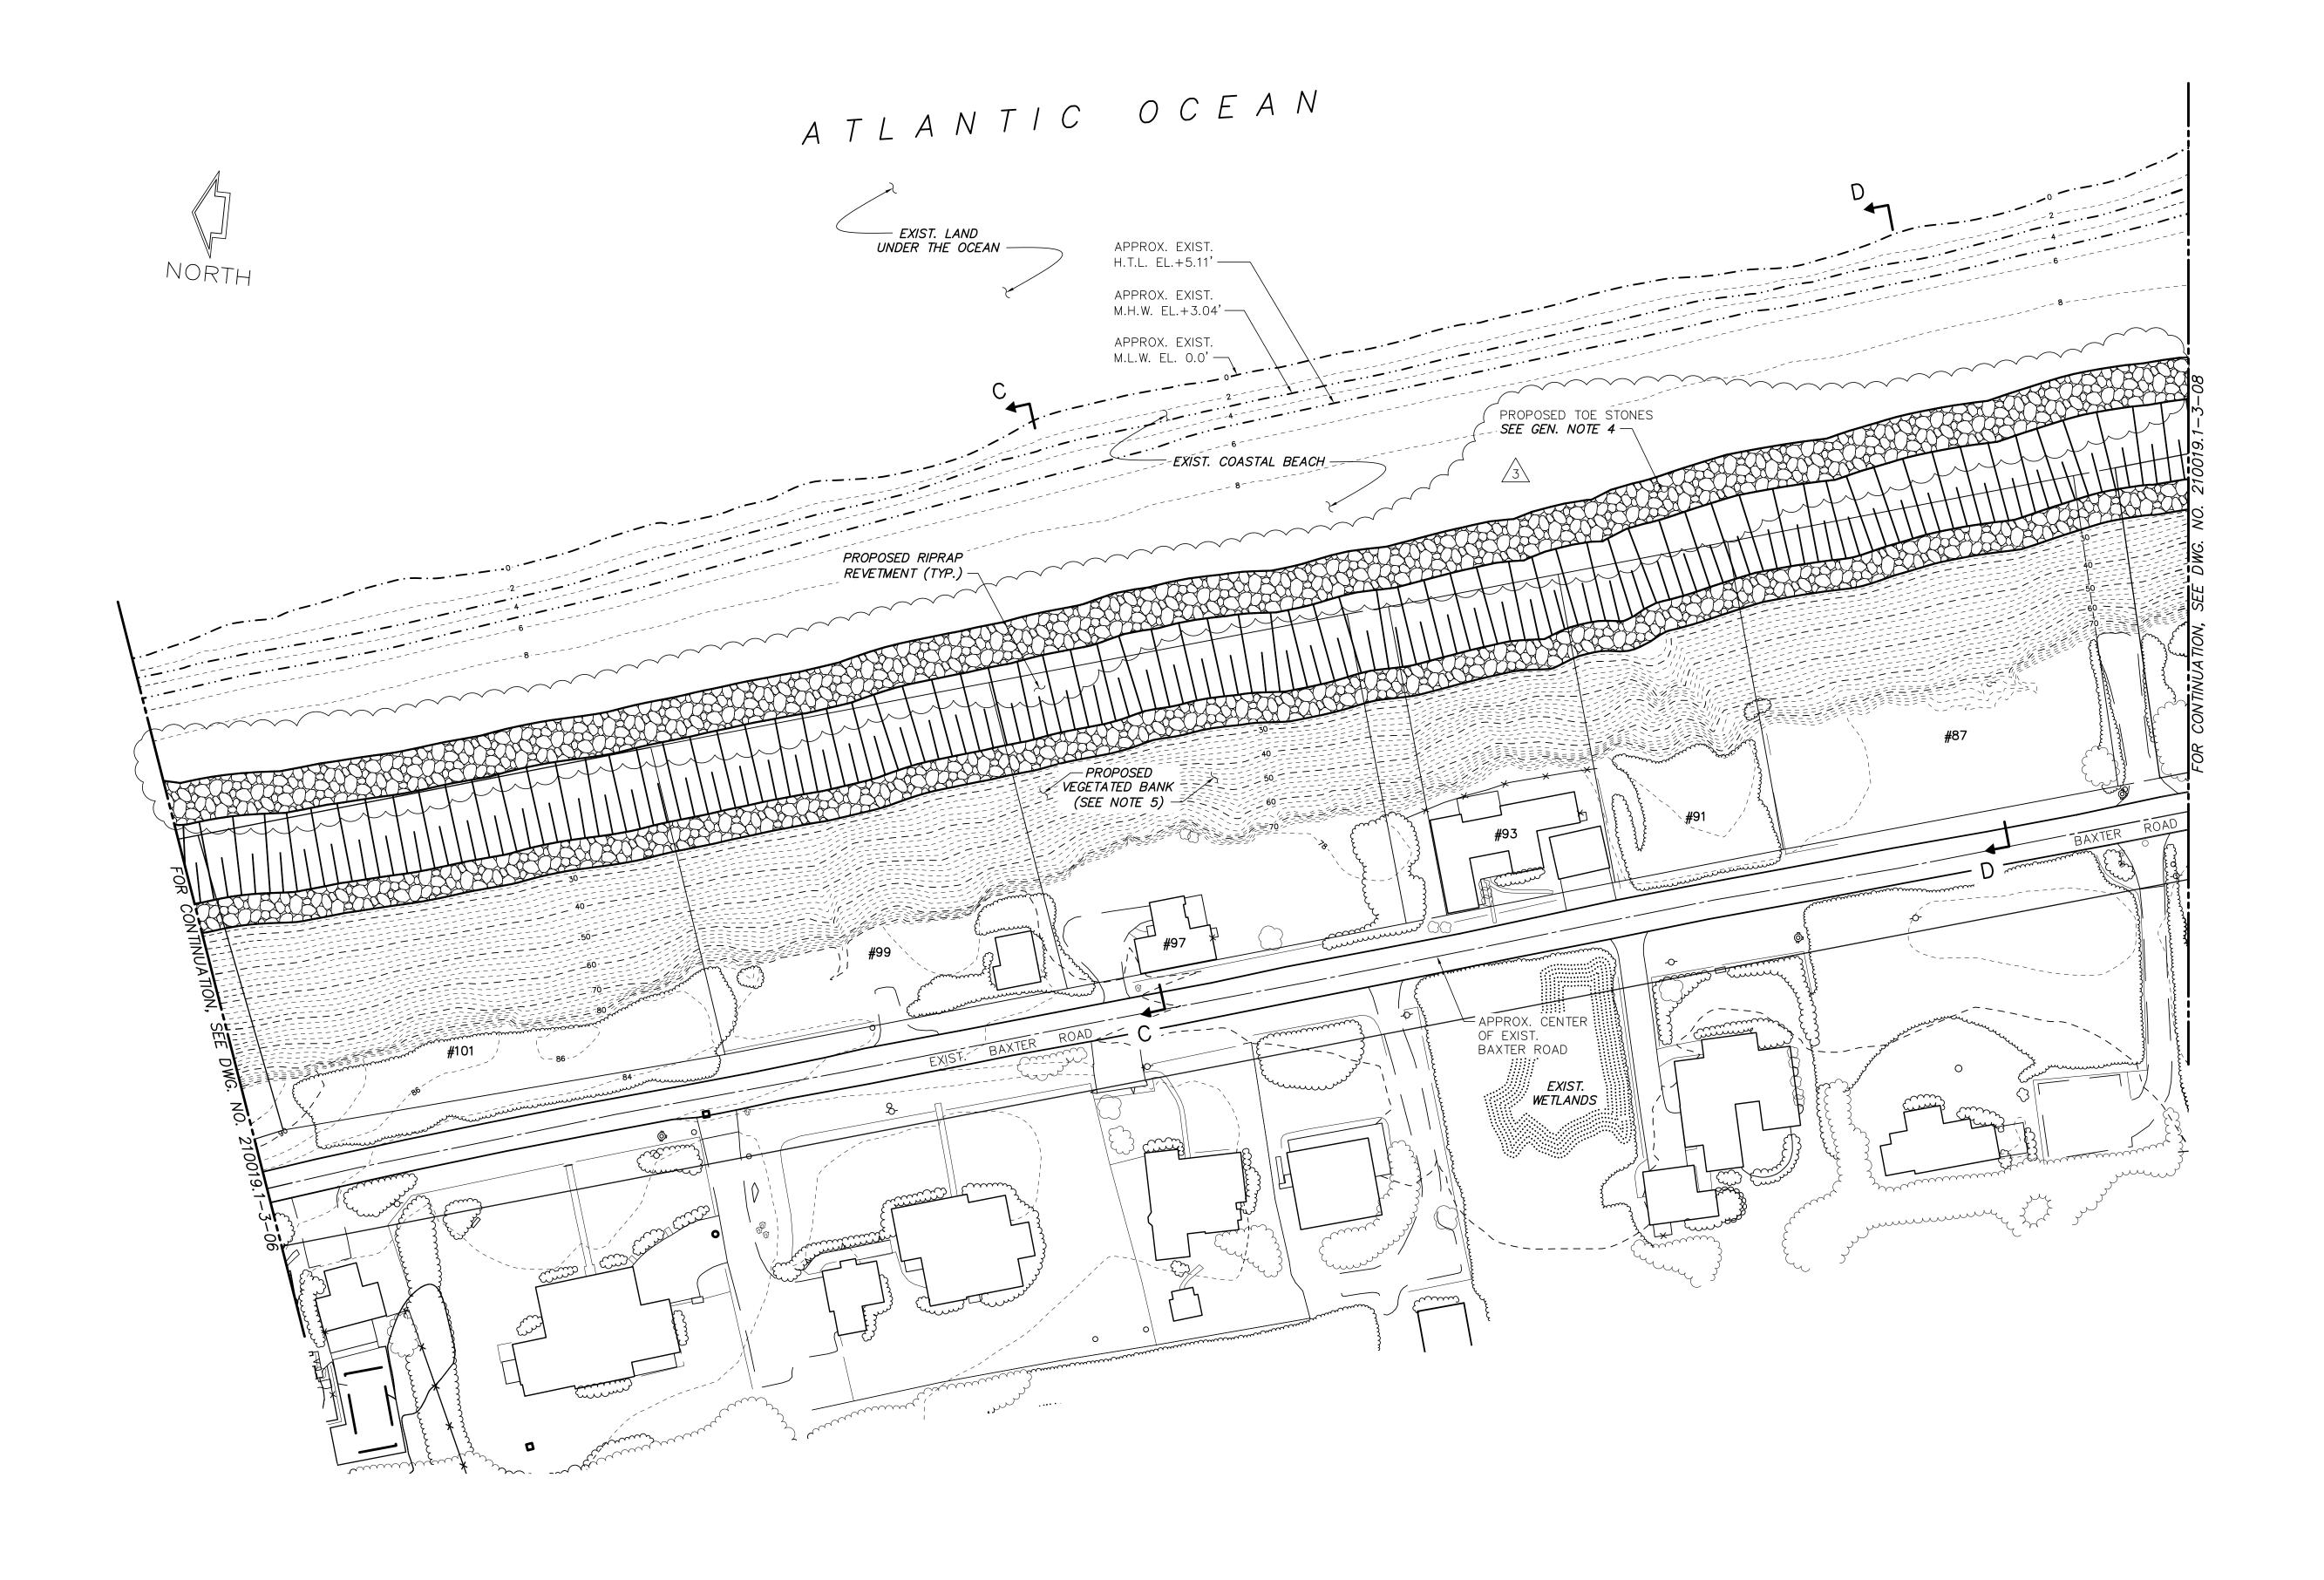
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SCONSET BEACH PRESERVATION FLIND

	FILE 3		A HON F	שמוט
18	Sesapana	Road,	Nantucket,	MA 02554

ADKA DRAWN BY: CAMA CHECKED BY:	SCONSET BLUFF EROSION CONTROL PROJECT NOTICE OF INTENT	A 6
AZSL QC REVIEW: JOMA	PROPOSED SITE PLAN - SHEET 1 OF 4	21

AS NOTED DATE 6/28/13 DRAWING NO.



- ALL ELEVATIONS ARE BASED ON MEAN LOW WATER DATUM (M.L.W.=0.0').
- 2. CONTOURS SHOWN IN 2 FOOT INTERVALS.
- 3. EXISTING TOPOGRAPHIC SURVEY INFORMATION SHOWN ON THIS PLAN TAKEN FROM A LIDAR SURVEY PROVIDED BY COL—EAST AND BLACKWELL & ASSOCIATES, INC. PERFORMED ON JULY 15, 2013 AND CAN ONLY REFLECT CONDITIONS AS THEY EXISTED AT THE TIME OF THE SURVEY.
- 4. SACRIFICIAL SAND COVER OVER THE REVETMENT NOT SHOWN FOR CLARITY. SEE PROPOSED SECTION C-C ON DWG. NO. 210019.1-3-12 AND PROPOSED SECTION D-D ON DWG. NO. 210019.1-3-13.
- 5. LIMITS OF THE PROPOSED RE-VEGETATION NOT SHOWN FOR CLARITY. REFER TO SECTION DRAWINGS ON DWG. NOS. 210019.1-3-10 THRU 16 FOR THE EXTENTS OF PROPOSED RE-VEGETATION.

GRAPHIC SCALES

CHECK GRAPHIC SCALES BEFORE USING

1"=40'-0"

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REVISIONS		DESCRIPTION			DESCRIPTION		BY	
	1	REVISED TOPOGRAPHIC SURVEY INFORMATION	8/14/13	BRJ0				
	2	REVISED SLOPE PROTECTION DESIGN	8/23/13	BRJ0				
R	3	ADDED CALLOUT	8/27/13	AZSL				
								1

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SCONSET BEACH PRESERVATION FUND


18 Sesapana Road, Nantucket, MA 02554

DESIGNED BY: ADKA DRAWN BY: CAMA	SCONSET BLUFF EROSION CONTROL PROJECT NOTICE OF INTENT	A
CHECKED BY: AZSL		
QC REVIEW: JOMA	PROPOSED SITE PLAN - SHEET 2 OF 4	21

AS NOTED

DATE
6/28/13

DRAWING NO.

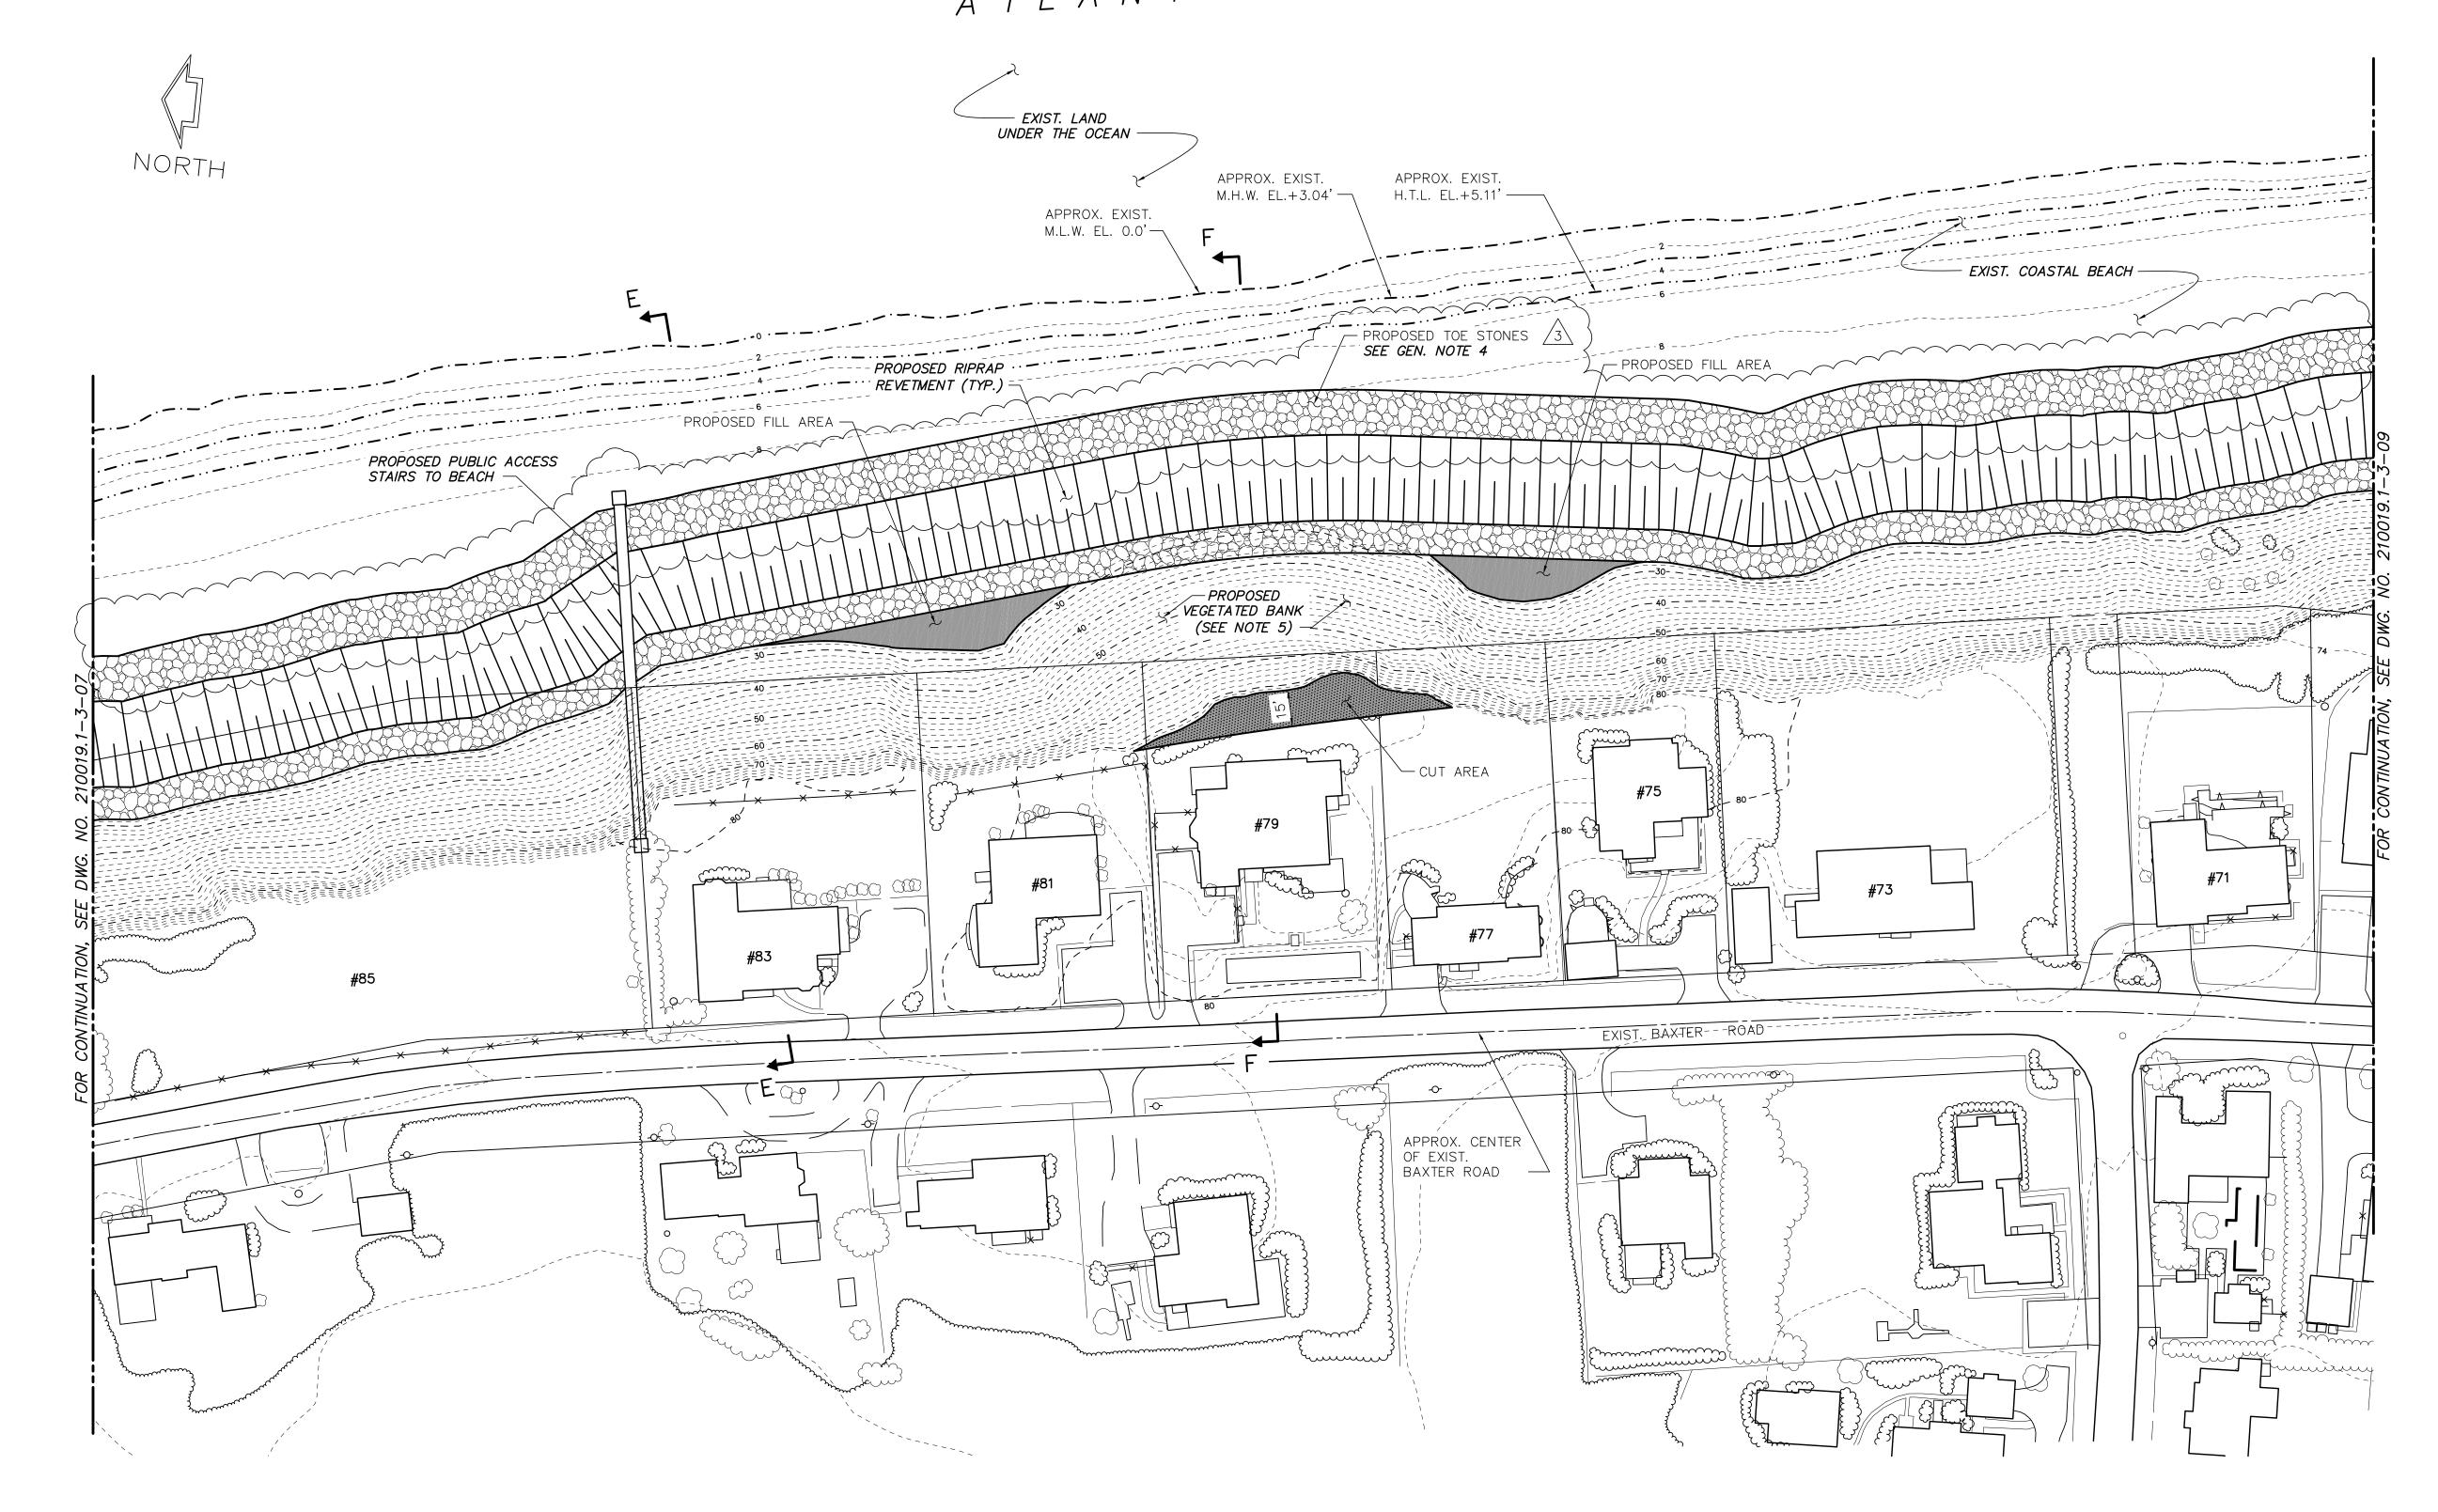

- 1. ALL ELEVATIONS ARE BASED ON MEAN LOW WATER DATUM (M.L.W.=0.0').
- 2. CONTOURS SHOWN IN 2 FOOT INTERVALS.
- 3. EXISTING TOPOGRAPHIC SURVEY INFORMATION SHOWN ON THIS PLAN TAKEN FROM A LIDAR SURVEY PROVIDED BY COL-EAST AND BLACKWELL & ASSOCIATES, INC. PERFORMED ON JULY 15, 2013 AND CAN ONLY REFLECT CONDITIONS AS THEY EXISTED AT THE TIME OF THE SURVEY.
- 4. SACRIFICIAL SAND COVER OVER THE REVETMENT NOT SHOWN FOR CLARITY. SEE PROPOSED SECTION E-E ON DWG. NO. 210019.1-3-14 AND PROPOSED SECTION F-F ON DWG. NO. 210019.1-3-15.
- 5. LIMITS OF THE PROPOSED RE-VEGETATION NOT SHOWN FOR CLARITY. REFER TO SECTION DRAWINGS ON DWG. NOS. 210019.1-3-10 THRU 16 FOR THE EXTENTS OF PROPOSED RE-VEGETATION.

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REVISIONS	DESCRIPTION		DATE	BY	DESCRIPTION DATE	BY
	1	REVISED TOPOGRAPHIC SURVEY INFORMATION	8/14/13	BRJ0		
	2	REVISED SLOPE PROTECTION DESIGN	8/23/13	BRJ0		
	3	ADDED CALLOUT	8/27/13	AZSL		

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SCONSET BEACH PRESERVATION FUND

18 Sesapana Road, Nantucket, MA 02554

DESIGNED BY: ADKA DRAWN BY: CAMA CHECKED BY:	SCONSET BLUFF EROSION CONTROL PROJECT NOTICE OF INTENT	SCALE AS NOTED DATE 6/28/13
AZSL		DRAWING
QC REVIEW: JOMA	PROPOSED SITE PLAN - SHEET 3 OF 4	210019.1-

6/28/13 DRAWING NO.

- 1. ALL ELEVATIONS ARE BASED ON MEAN LOW WATER DATUM (M.L.W.=0.0').
- 2. CONTOURS SHOWN IN 2 FOOT INTERVALS.
- 3. EXISTING TOPOGRAPHIC SURVEY INFORMATION SHOWN ON THIS PLAN TAKEN FROM A LIDAR SURVEY PROVIDED BY COL—EAST AND BLACKWELL & ASSOCIATES, INC. PERFORMED ON JULY 15, 2013 AND CAN ONLY REFLECT CONDITIONS AS THEY EXISTED AT THE TIME OF THE SURVEY.
- 4. SACRIFICIAL SAND COVER OVER THE REVETMENT NOT SHOWN FOR CLARITY. SEE PROPOSED SECTION G-G ON DWG. NO. 210019.1-3-16.
- 5. LIMITS OF THE PROPOSED RE-VEGETATION NOT SHOWN FOR CLARITY. REFER TO SECTION DRAWINGS ON DWG. NOS. 210019.1-3-10 THRU 16 FOR THE EXTENTS OF PROPOSED RE-VEGETATION.
- 6. PROPOSED STONES AT REVETMENT TERMINUS TO BE TAPERED BACK INTO EXISTING BANK. PLACEMENT AT ENDS TO BE FIELD COORDINATED WITH ENGINEER.

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	DESCRIPTION			BY	DESCRIPTION	DATE	BY	
S	1	REVISED TOPOGRAPHIC SURVEY INFORMATION	8/14/13	BRJ0				
SNOISINE	2	REVISED SLOPE PROTECTION DESIGN	8/23/13	BRJ0				
RE	3	ADDED GENERAL NOTE 6; REVISED REVETMENT	8/27/13	AZSL				
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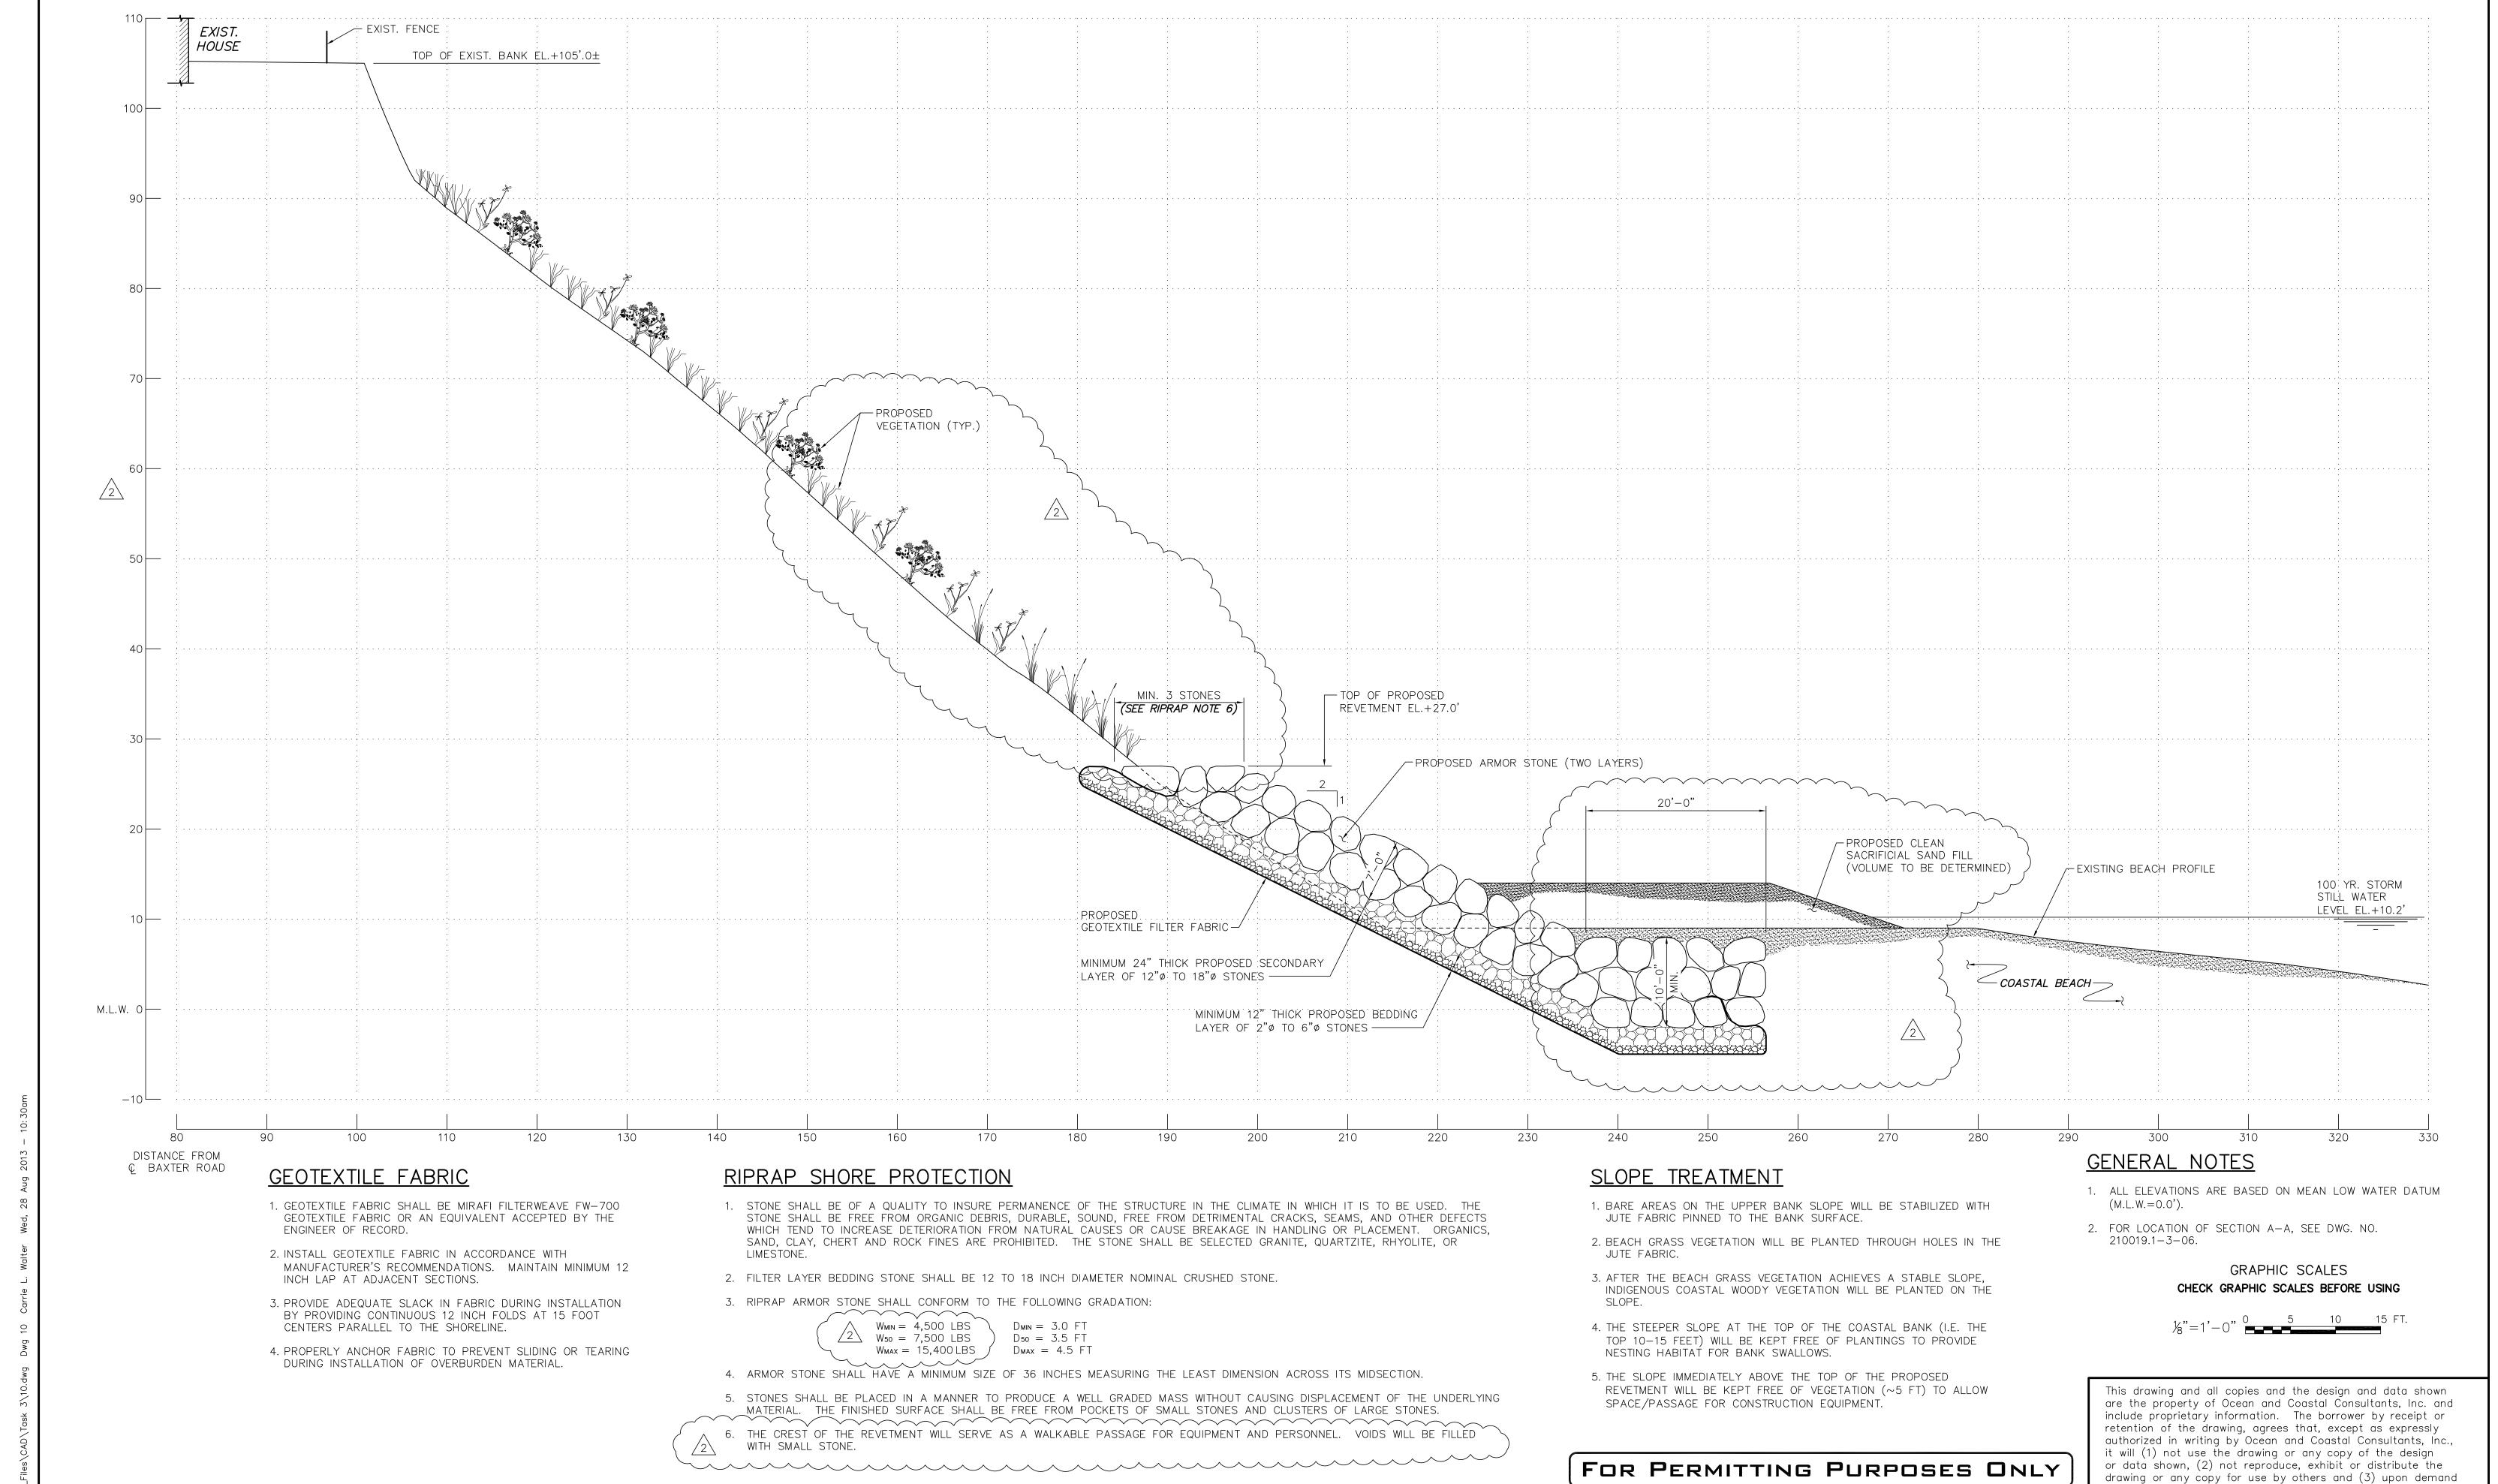
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SCONSET BEACH PRESERVATION FUND

18 Sesapana Road, Nantucket, MA 02554

DESIGNED BY: ADKA DRAWN BY: CAMA	SCONSET BLUFF EROSION CONTROL PROJECT NOTICE OF INTENT	AS
CHECKED BY: AZSL		
QC REVIEW: JOMA	PROPOSED SITE PLAN - SHEET 4 OF 4	21

SCALE AS NOTED DATE 6/28/13 DRAWING NO.



DATE BY DATE BY DESCRIPTION DESCRIPTION REVISED SLOPE PROTECTION DESIGN 8/23/13 BRJ0 8/27/13 AZSL REVISED TOE DESIGN; ADDED RIPRAP NOTE 6

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SCONSET BEACH PRESERVATION FUND

18 Sesapana Road, Nantucket, MA 02554

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DESIGNED BY:	SCONSET BLUFF E	TRACIONI CANTRAI		SCALE 1/8"=1'-0"	REVISION
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CAMA

AZSL


JOMA

CHECKED BY:

QC REVIEW:

ROL PROJECT /8"=1'-0" DATE NOTICE OF INTENT 8/11/13 DRAWING NO.

PROPOSED SECTION A-A AT LOT 115

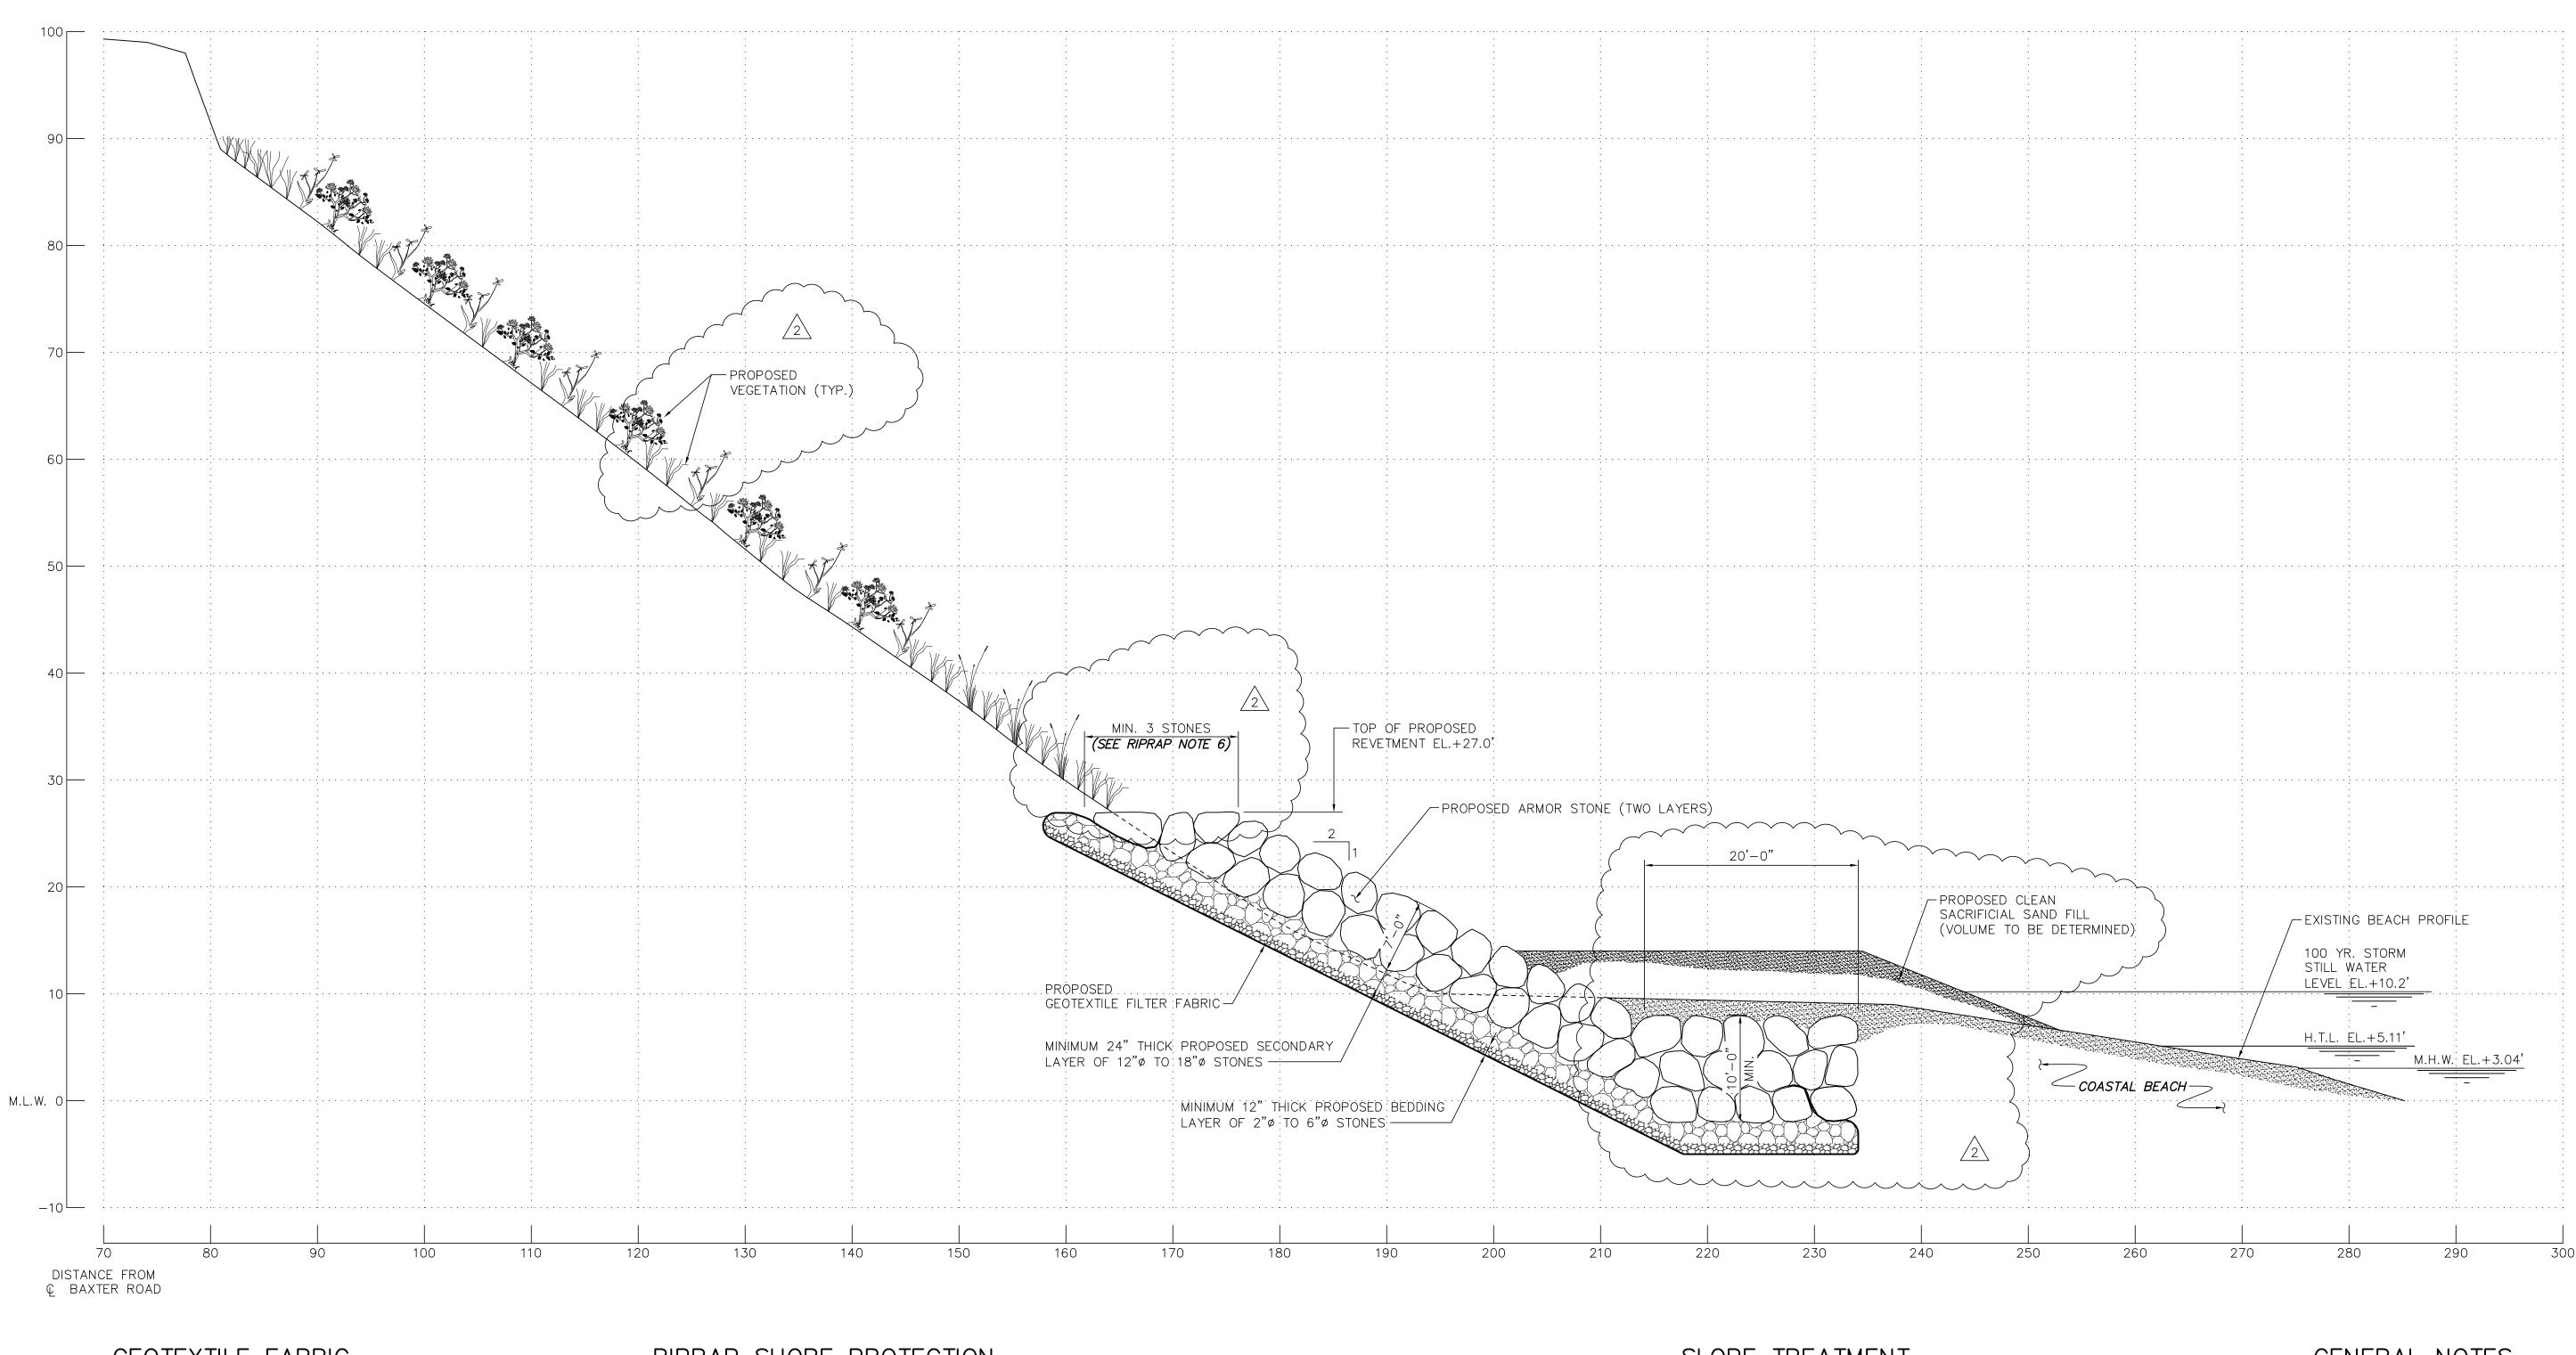

- 1. GEOTEXTILE FABRIC SHALL BE MIRAFI FILTERWEAVE FW-700 GEOTEXTILE FABRIC OR AN EQUIVALENT ACCEPTED BY THE ENGINEER OF RECORD.
- 2. INSTALL GEOTEXTILE FABRIC IN ACCORDANCE WITH MANUFACTURER'S RECOMMENDATIONS. MAINTAIN MINIMUM 12 INCH LAP AT ADJACENT SECTIONS.
- 3. PROVIDE ADEQUATE SLACK IN FABRIC DURING INSTALLATION BY PROVIDING CONTINUOUS 12 INCH FOLDS AT 15 FOOT CENTERS PARALLEL TO THE SHORELINE.
- 4. PROPERLY ANCHOR FABRIC TO PREVENT SLIDING OR TEARING DURING INSTALLATION OF OVERBURDEN MATERIAL.

RIPRAP SHORE PROTECTION

- 1. STONE SHALL BE OF A QUALITY TO INSURE PERMANENCE OF THE STRUCTURE IN THE CLIMATE IN WHICH IT IS TO BE USED. THE STONE SHALL BE FREE FROM ORGANIC DEBRIS, DURABLE, SOUND, FREE FROM DETRIMENTAL CRACKS, SEAMS, AND OTHER DEFECTS WHICH TEND TO INCREASE DETERIORATION FROM NATURAL CAUSES OR CAUSE BREAKAGE IN HANDLING OR PLACEMENT. ORGANICS, SAND, CLAY, CHERT AND ROCK FINES ARE PROHIBITED. THE STONE SHALL BE SELECTED GRANITE, QUARTZITE, RHYOLITE, OR LIMESTONE.
- 2. FILTER LAYER BEDDING STONE SHALL BE 12 TO 18 INCH DIAMETER NOMINAL CRUSHED STONE.
- 3. RIPRAP ARMOR STONE SHALL CONFORM TO THE FOLLOWING GRADATION:

 $W_{MIN} = 4,500 LBS$ $D_{MIN} = 3.0 FT$ $W_{50} = 7,500 LBS$ $D_{50} = 3.5 \text{ FT}$ $W_{MAX} = 15,400 LBS$ $D_{MAX} = 4.5 FT$

- 4. ARMOR STONE SHALL HAVE A MINIMUM SIZE OF 36 INCHES MEASURING THE LEAST DIMENSION ACROSS ITS MIDSECTION.
- 5. STONES SHALL BE PLACED IN A MANNER TO PRODUCE A WELL GRADED MASS WITHOUT CAUSING DISPLACEMENT OF THE UNDERLYING MATERIAL. THE FINISHED SURFACE SHALL BE FREE FROM POCKETS OF SMALL STONES AND CLUSTERS OF LARGE STONES. 6. THE CREST OF THE REVETMENT WILL SERVE AS A WALKABLE PASSAGE FOR EQUIPMENT AND PERSONNEL. VOIDS WILL BE FILLED

WITH SMALL STONE.

SLOPE TREATMENT

- 1. BARE AREAS ON THE UPPER BANK SLOPE WILL BE STABILIZED WITH JUTE FABRIC PINNED TO THE BANK SURFACE.
- 2. BEACH GRASS VEGETATION WILL BE PLANTED THROUGH HOLES IN THE JUTE FABRIC.
- 3. AFTER THE BEACH GRASS VEGETATION ACHIEVES A STABLE SLOPE, INDIGENOUS COASTAL WOODY VEGETATION WILL BE PLANTED ON THE SLOPE.
- 4. THE STEEPER SLOPE AT THE TOP OF THE COASTAL BANK (I.E. THE TOP 10-15 FEET) WILL BE KEPT FREE OF PLANTINGS TO PROVIDE NESTING HABITAT FOR BANK SWALLOWS.
- 5. THE SLOPE IMMEDIATELY ABOVE THE TOP OF THE PROPOSED REVETMENT WILL BE KEPT FREE OF VEGETATION (~5 FT) TO ALLOW SPACE/PASSAGE FOR CONSTRUCTION EQUIPMENT.

FOR PERMITTING PURPOSES ONLY

GENERAL NOTES

- 1. ALL ELEVATIONS ARE BASED ON MEAN LOW WATER DATUM (M.L.W.=0.0').
- 2. FOR LOCATION OF SECTION B-B, SEE DWG. NO. 210019.1-3-06.

GRAPHIC SCALES CHECK GRAPHIC SCALES BEFORE USING

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DATE BY DATE BY DESCRIPTION DESCRIPTION REVISED SLOPE PROTECTION DESIGN 8/23/13 BRJ0 8/27/13 AZSL REVISED TOE DESIGN; ADDED RIPRAP NOTE 6

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SCONSET BEACH PRESERVATION FUND

18 Sesapana Road, Nantucket, MA 02554

DRAWN BY: CAMA	SCONSET BLUFF EROSION CONTROL PROJECT NOTICE OF INTENT	
CHECKED BY: AZSL		
QC REVIEW: JOMA	PROPOSED SECTION B-B AT LOT 107	

DRAWING NO.

1/8"=1'-0"

DATE

8/11/13

- 1. GEOTEXTILE FABRIC SHALL BE MIRAFI FILTERWEAVE FW-700 GEOTEXTILE FABRIC OR AN EQUIVALENT ACCEPTED BY THE ENGINEER OF RECORD.
- 2. INSTALL GEOTEXTILE FABRIC IN ACCORDANCE WITH MANUFACTURER'S RECOMMENDATIONS. MAINTAIN MINIMUM 12 INCH LAP AT ADJACENT SECTIONS.
- 3. PROVIDE ADEQUATE SLACK IN FABRIC DURING INSTALLATION BY PROVIDING CONTINUOUS 12 INCH FOLDS AT 15 FOOT CENTERS PARALLEL TO THE SHORELINE.
- 4. PROPERLY ANCHOR FABRIC TO PREVENT SLIDING OR TEARING DURING INSTALLATION OF OVERBURDEN MATERIAL.

8/27/13 AZSL

REVISED TOE DESIGN; ADDED RIPRAP NOTE 6

RIPRAP SHORE PROTECTION

- 1. STONE SHALL BE OF A QUALITY TO INSURE PERMANENCE OF THE STRUCTURE IN THE CLIMATE IN WHICH IT IS TO BE USED. THE STONE SHALL BE FREE FROM ORGANIC DEBRIS, DURABLE, SOUND, FREE FROM DETRIMENTAL CRACKS, SEAMS, AND OTHER DEFECTS WHICH TEND TO INCREASE DETERIORATION FROM NATURAL CAUSES OR CAUSE BREAKAGE IN HANDLING OR PLACEMENT. ORGANICS, SAND, CLAY, CHERT AND ROCK FINES ARE PROHIBITED. THE STONE SHALL BE SELECTED GRANITE, QUARTZITE, RHYOLITE, OR LIMESTONE.
- 2. FILTER LAYER BEDDING STONE SHALL BE 12 TO 18 INCH DIAMETER NOMINAL CRUSHED STONE.
- 3. RIPRAP ARMOR STONE SHALL CONFORM TO THE FOLLOWING GRADATION:

 $W_{MIN} = 4,500 LBS$ $W_{50} = 7,500 LBS$ $W_{MAX} = 15,400 LBS$

 $D_{MIN} = 3.0 FT$ $D_{50} = 3.5 \text{ FT}$

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Phone: (508) 830-1110 Fax: (781) 834-4635 Visit us at www.ocean-coastal.com

 $D_{MAX} = 4.5 FT$

- 4. ARMOR STONE SHALL HAVE A MINIMUM SIZE OF 36 INCHES MEASURING THE LEAST DIMENSION ACROSS ITS MIDSECTION.
- 5. STONES SHALL BE PLACED IN A MANNER TO PRODUCE A WELL GRADED MASS WITHOUT CAUSING DISPLACEMENT OF THE UNDERLYING MATERIAL. THE FINISHED SURFACE SHALL BE FREE FROM POCKETS OF SMALL STONES AND CLUSTERS OF LARGE STONES.
- 6. THE CREST OF THE REVETMENT WILL SERVE AS A WALKABLE PASSAGE FOR EQUIPMENT AND PERSONNEL. VOIDS WILL BE FILLED WITH SMALL STONE.

SLOPE TREATMENT

18 Sesapana Road, Nantucket, MA 02554

- 1. BARE AREAS ON THE UPPER BANK SLOPE WILL BE STABILIZED WITH JUTE FABRIC PINNED TO THE BANK SURFACE.
- 2. BEACH GRASS VEGETATION WILL BE PLANTED THROUGH HOLES IN THE JUTE FABRIC.
- 3. AFTER THE BEACH GRASS VEGETATION ACHIEVES A STABLE SLOPE, INDIGENOUS COASTAL WOODY VEGETATION WILL BE PLANTED ON THE SLOPE.
- 4. THE STEEPER SLOPE AT THE TOP OF THE COASTAL BANK (I.E. THE TOP 10-15 FEET) WILL BE KEPT FREE OF PLANTINGS TO PROVIDE NESTING HABITAT FOR BANK SWALLOWS.
- 5. THE SLOPE IMMEDIATELY ABOVE THE TOP OF THE PROPOSED REVETMENT WILL BE KEPT FREE OF VEGETATION (~5 FT) TO ALLOW SPACE/PASSAGE FOR CONSTRUCTION EQUIPMENT.

GENERAL NOTES

- 1. ALL ELEVATIONS ARE BASED ON MEAN LOW WATER DATUM (M.L.W.=0.0').
- 2. FOR LOCATION OF SECTION C-C, SEE DWG. NO. 210019.1-3-07.

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REVISION

DATE


6/28/13

DRAWING NO.

FOR PERMITTING PURPOSES ONLY

DESCRIPTION	DATF	BY	DESCRIPTION	DATE BY			DESIGNED BY:
							ADKA
1 REVISED SECTION	8/14/13	BRJO			Ocean and Coastal CCC COVI	SCONSET BEACH	DRAWN BY: CAMA
							CHECKED BY:
2 REVISED SLOPE PROTECTION DESIGN	8/23/13	BRJ0			Ocean and Coastal Consultants, Inc.	PRESERVATION FUND	AZSL

SCONSET BLUFF EROSION CONTROL PROJECT ADKA /8"=1'-0" NOTICE OF INTENT AWN BY: CAMA ECKED BY: AZSL QC REVIEW: PROPOSED SECTION C-C AT LOT 97 210019.1-3-12 JOMA

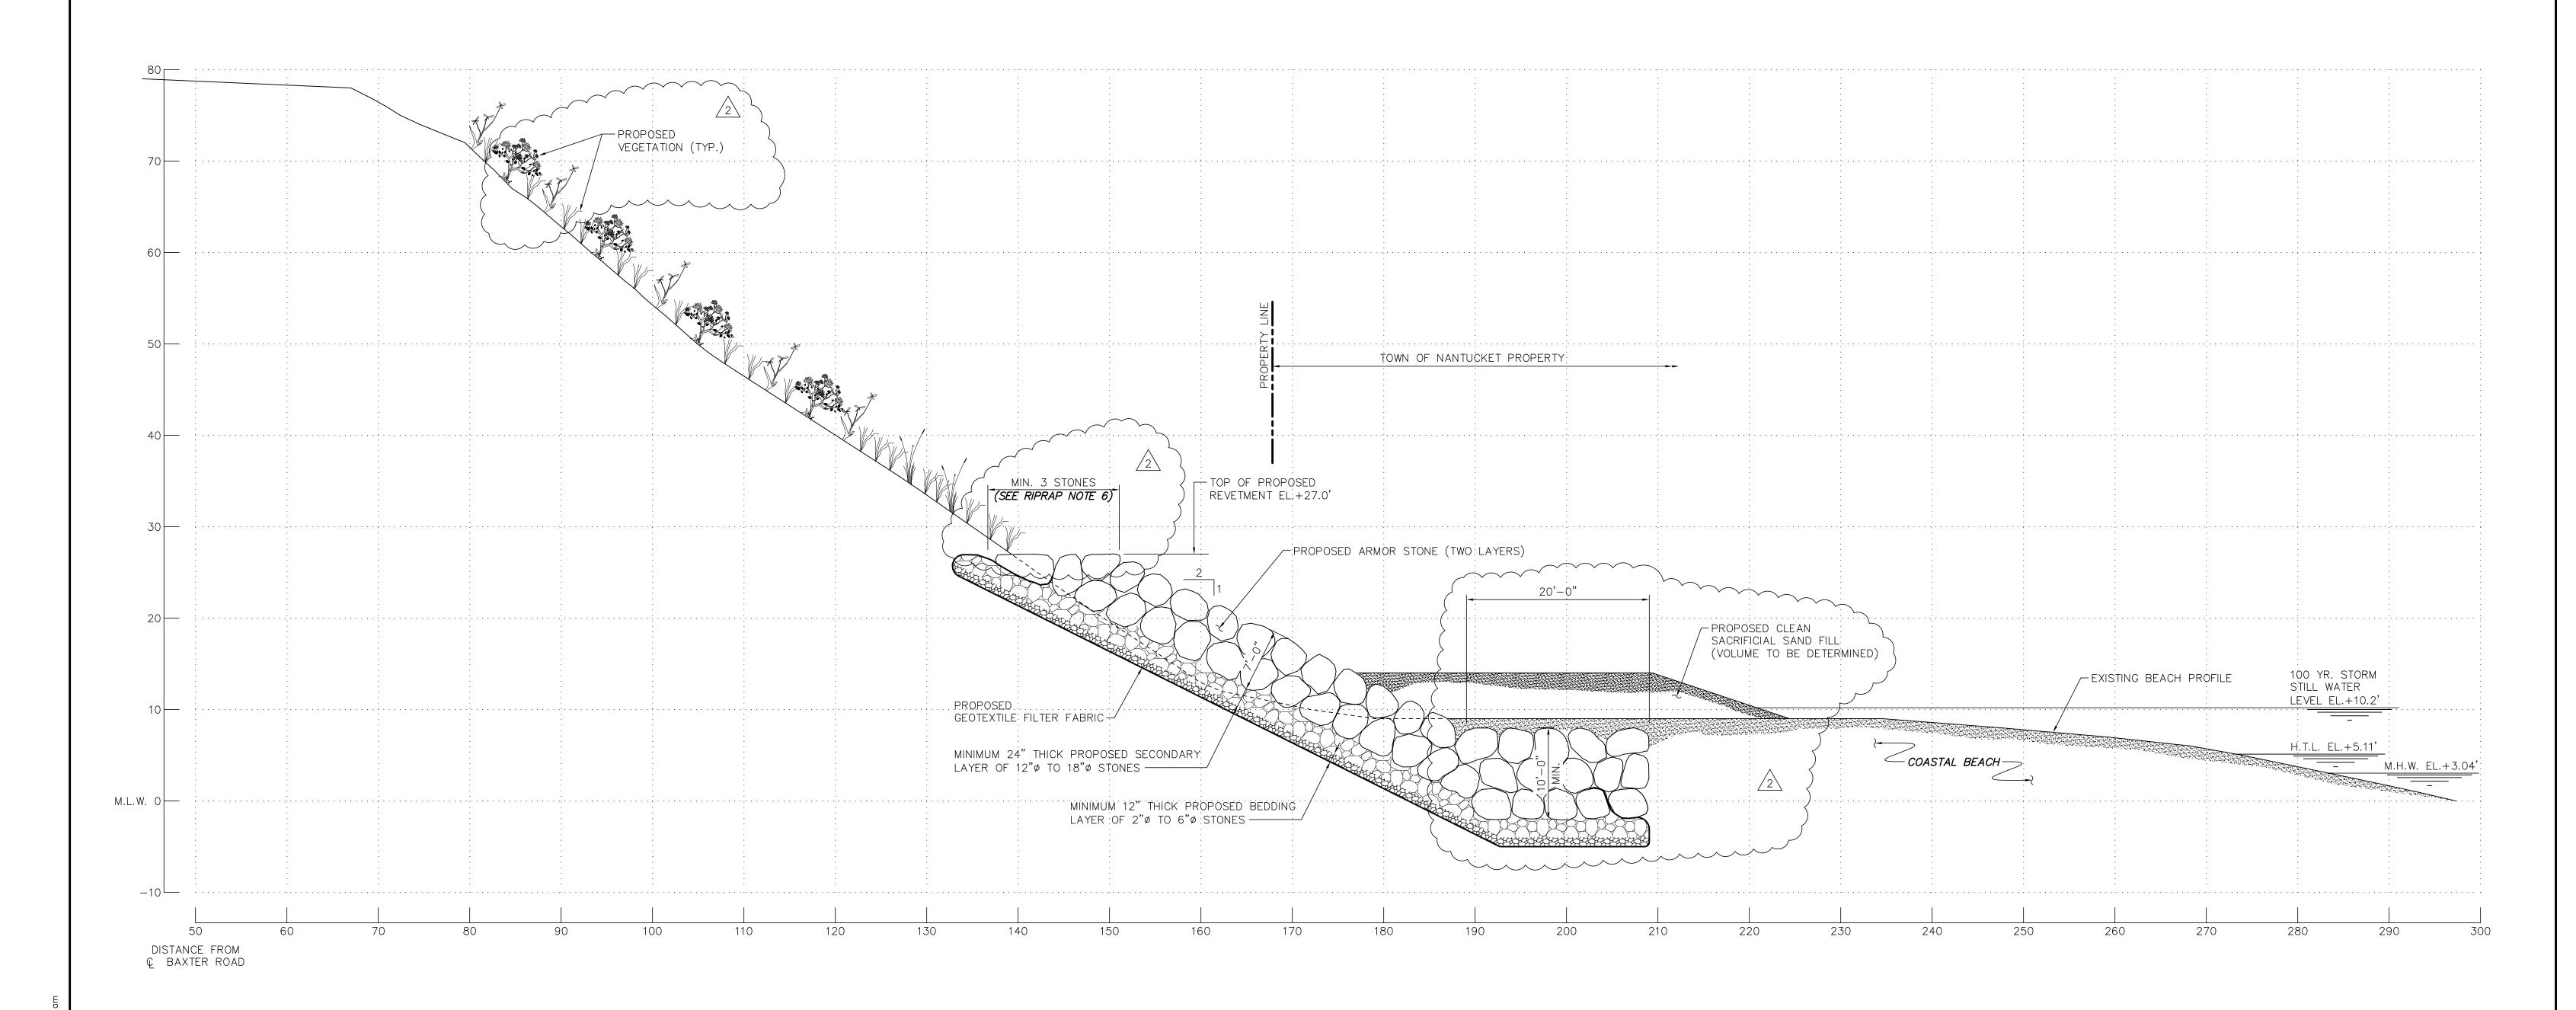

- 1. GEOTEXTILE FABRIC SHALL BE MIRAFI FILTERWEAVE FW-700 GEOTEXTILE FABRIC OR AN EQUIVALENT ACCEPTED BY THE ENGINEER OF RECORD.
- 2. INSTALL GEOTEXTILE FABRIC IN ACCORDANCE WITH MANUFACTURER'S RECOMMENDATIONS. MAINTAIN MINIMUM 12 INCH LAP AT ADJACENT SECTIONS.
- 3. PROVIDE ADEQUATE SLACK IN FABRIC DURING INSTALLATION BY PROVIDING CONTINUOUS 12 INCH FOLDS AT 15 FOOT CENTERS PARALLEL TO THE SHORELINE.
- 4. PROPERLY ANCHOR FABRIC TO PREVENT SLIDING OR TEARING DURING INSTALLATION OF OVERBURDEN MATERIAL.

RIPRAP SHORE PROTECTION

- 1. STONE SHALL BE OF A QUALITY TO INSURE PERMANENCE OF THE STRUCTURE IN THE CLIMATE IN WHICH IT IS TO BE USED. THE STONE SHALL BE FREE FROM ORGANIC DEBRIS, DURABLE, SOUND, FREE FROM DETRIMENTAL CRACKS, SEAMS, AND OTHER DEFECTS WHICH TEND TO INCREASE DETERIORATION FROM NATURAL CAUSES OR CAUSE BREAKAGE IN HANDLING OR PLACEMENT. ORGANICS, SAND, CLAY, CHERT AND ROCK FINES ARE PROHIBITED. THE STONE SHALL BE SELECTED GRANITE, QUARTZITE, RHYOLITE, OR LIMESTONE.
- 2. FILTER LAYER BEDDING STONE SHALL BE 12 TO 18 INCH DIAMETER NOMINAL CRUSHED STONE.
- 3. RIPRAP ARMOR STONE SHALL CONFORM TO THE FOLLOWING GRADATION:

 $W_{MIN} = 4,500 LBS$ $D_{MIN} = 3.0 FT$ $W_{50} = 7,500 LBS$ $D_{50} = 3.5 \text{ FT}$ $W_{MAX} = 15,400 LBS$ $D_{MAX} = 4.5 FT$

- 4. ARMOR STONE SHALL HAVE A MINIMUM SIZE OF 36 INCHES MEASURING THE LEAST DIMENSION ACROSS ITS MIDSECTION.
- 5. STONES SHALL BE PLACED IN A MANNER TO PRODUCE A WELL GRADED MASS WITHOUT CAUSING DISPLACEMENT OF THE UNDERLYING MATERIAL. THE FINISHED SURFACE SHALL BE FREE FROM POCKETS OF SMALL STONES AND CLUSTERS OF LARGE STONES. 6. THE CREST OF THE REVETMENT WILL SERVE AS A WALKABLE PASSAGE FOR EQUIPMENT AND PERSONNEL. VOIDS WILL BE FILLED WITH SMALL STONE.

SLOPE TREATMENT

- 1. BARE AREAS ON THE UPPER BANK SLOPE WILL BE STABILIZED WITH JUTE FABRIC PINNED TO THE BANK SURFACE.
- 2. BEACH GRASS VEGETATION WILL BE PLANTED THROUGH HOLES IN THE JUTE FABRIC.
- 3. AFTER THE BEACH GRASS VEGETATION ACHIEVES A STABLE SLOPE, INDIGENOUS COASTAL WOODY VEGETATION WILL BE PLANTED ON THE SLOPE.
- 4. THE STEEPER SLOPE AT THE TOP OF THE COASTAL BANK (I.E. THE TOP 10-15 FEET) WILL BE KEPT FREE OF PLANTINGS TO PROVIDE NESTING HABITAT FOR BANK SWALLOWS.
- 5. THE SLOPE IMMEDIATELY ABOVE THE TOP OF THE PROPOSED REVETMENT WILL BE KEPT FREE OF VEGETATION (~5 FT) TO ALLOW SPACE/PASSAGE FOR CONSTRUCTION EQUIPMENT.

GENERAL NOTES

- 1. ALL ELEVATIONS ARE BASED ON MEAN LOW WATER DATUM (M.L.W.=0.0').
- 2. FOR LOCATION OF SECTION D-D, SEE DWG. NO. 210019.1-3-07.

GRAPHIC SCALES CHECK GRAPHIC SCALES BEFORE USING



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	DESCRIPTION		DATE	BY	DESCRIPTION	DATE	BY	
S	1	REVISED SLOPE PROTECTION DESIGN	8/23/13	BRJO				
REVISIONS	2	REVISED TOE DESIGN; ADDED RIPRAP NOTE 6	8/27/13	AZSL				
R								

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SCONSET BEACH PRESERVATION FUND

18 Sesapana Road, Nantucket, MA 02554

CHECKED BY: AZSL QC REVIEW: JOMA	PROPOSED SECTION D-D AT LOT 87	DRAWING 210019.1-	
DESIGNED BY: ADKA DRAWN BY: CAMA	SCONSET BLUFF EROSION CONTROL PROJECT NOTICE OF INTENT	1/8"=1'-0" DATE 8/11/13	2

Ç BAXTER ROAD

- 1. GEOTEXTILE FABRIC SHALL BE MIRAFI FILTERWEAVE FW-700 GEOTEXTILE FABRIC OR AN EQUIVALENT ACCEPTED BY THE ENGINEER OF RECORD.
- 2. INSTALL GEOTEXTILE FABRIC IN ACCORDANCE WITH MANUFACTURER'S RECOMMENDATIONS. MAINTAIN MINIMUM 12 INCH LAP AT ADJACENT SECTIONS.
- 3. PROVIDE ADEQUATE SLACK IN FABRIC DURING INSTALLATION BY PROVIDING CONTINUOUS 12 INCH FOLDS AT 15 FOOT CENTERS PARALLEL TO THE SHORELINE.
- 4. PROPERLY ANCHOR FABRIC TO PREVENT SLIDING OR TEARING DURING INSTALLATION OF OVERBURDEN MATERIAL.

RIPRAP SHORE PROTECTION

- 1. STONE SHALL BE OF A QUALITY TO INSURE PERMANENCE OF THE STRUCTURE IN THE CLIMATE IN WHICH IT IS TO BE USED. THE STONE SHALL BE FREE FROM ORGANIC DEBRIS, DURABLE, SOUND, FREE FROM DETRIMENTAL CRACKS, SEAMS, AND OTHER DEFECTS WHICH TEND TO INCREASE DETERIORATION FROM NATURAL CAUSES OR CAUSE BREAKAGE IN HANDLING OR PLACEMENT. ORGANICS, SAND, CLAY, CHERT AND ROCK FINES ARE PROHIBITED. THE STONE SHALL BE SELECTED GRANITE, QUARTZITE, RHYOLITE, OR
- 2. FILTER LAYER BEDDING STONE SHALL BE 12 TO 18 INCH DIAMETER NOMINAL CRUSHED STONE.
- 3. RIPRAP ARMOR STONE SHALL CONFORM TO THE FOLLOWING GRADATION:

 $W_{MIN} = 4,500 LBS$ $W_{50} = 7,500 LBS$

- $D_{50} = 3.5 FT$ $W_{MAX} = 15,400 LBS$ $D_{MAX} = 4.5 FT$
- 4. ARMOR STONE SHALL HAVE A MINIMUM SIZE OF 36 INCHES MEASURING THE LEAST DIMENSION ACROSS ITS MIDSECTION.
- 5. STONES SHALL BE PLACED IN A MANNER TO PRODUCE A WELL GRADED MASS WITHOUT CAUSING DISPLACEMENT OF THE UNDERLYING MATERIAL. THE FINISHED SURFACE SHALL BE FREE FROM POCKETS OF SMALL STONES AND CLUSTERS OF LARGE STONES. 6. THE CREST OF THE REVETMENT WILL SERVE AS A WALKABLE PASSAGE FOR EQUIPMENT AND PERSONNEL. VOIDS WILL BE FILLED WITH SMALL STONE.

SLOPE TREATMENT

- 1. BARE AREAS ON THE UPPER BANK SLOPE WILL BE STABILIZED WITH JUTE FABRIC PINNED TO THE BANK SURFACE.
- 2. BEACH GRASS VEGETATION WILL BE PLANTED THROUGH HOLES IN THE JUTE FABRIC.
- 3. AFTER THE BEACH GRASS VEGETATION ACHIEVES A STABLE SLOPE, INDIGENOUS COASTAL WOODY VEGETATION WILL BE PLANTED ON THE
- 4. THE STEEPER SLOPE AT THE TOP OF THE COASTAL BANK (I.E. THE TOP 10-15 FEET) WILL BE KEPT FREE OF PLANTINGS TO PROVIDE NESTING HABITAT FOR BANK SWALLOWS.

FOR PERMITTING PURPOSES ONLY

ADKA

5. THE SLOPE IMMEDIATELY ABOVE THE TOP OF THE PROPOSED REVETMENT WILL BE KEPT FREE OF VEGETATION (~5 FT) TO ALLOW SPACE/PASSAGE FOR CONSTRUCTION EQUIPMENT.

GENERAL NOTES

- 1. ALL ELEVATIONS ARE BASED ON MEAN LOW WATER DATUM (M.L.W.=0.0').
- 2. FOR LOCATION OF SECTION E-E, SEE DWG. NO. 210019.1-3-08.

GRAPHIC SCALES CHECK GRAPHIC SCALES BEFORE USING

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DATE BY DESCRIPTION DATE BY DESCRIPTION REVISED SECTION 8/14/13 BRJ0 8/23/13 BRJ0 REVISED SLOPE PROTECTION DESIGN

8/27/13 AZSL

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SCONSET BEACH PRESERVATION FUND

18 Sesapana Road, Nantucket, MA 02554

DRAWN BY:	NOTICE OF INTENT
CAMA	1101102 01 11112111
CHECKED BY:	
AZSL	
QC REVIEW:	PROPOSED SECTION E-E AT LOT 83
JOMA	Thereself seement E E AT EST SE

SCONSET BLUFF EROSION CONTROL PROJECT /8"=1'-0" NOTICE OF INTENT DATE

DRAWING NO.

210019.1-3-14

6/28/13

REVISED TOE DESIGN; ADDED RIPRAP NOTE 6

- 1. GEOTEXTILE FABRIC SHALL BE MIRAFI FILTERWEAVE FW-700 GEOTEXTILE FABRIC OR AN EQUIVALENT ACCEPTED BY THE ENGINEER OF RECORD.
- 2. INSTALL GEOTEXTILE FABRIC IN ACCORDANCE WITH MANUFACTURER'S RECOMMENDATIONS. MAINTAIN MINIMUM 12 INCH LAP AT ADJACENT SECTIONS.
- 3. PROVIDE ADEQUATE SLACK IN FABRIC DURING INSTALLATION BY PROVIDING CONTINUOUS 12 INCH FOLDS AT 15 FOOT CENTERS PARALLEL TO THE SHORELINE.
- 4. PROPERLY ANCHOR FABRIC TO PREVENT SLIDING OR TEARING DURING INSTALLATION OF OVERBURDEN MATERIAL.

RIPRAP SHORE PROTECTION

- 1. STONE SHALL BE OF A QUALITY TO INSURE PERMANENCE OF THE STRUCTURE IN THE CLIMATE IN WHICH IT IS TO BE USED. THE STONE SHALL BE FREE FROM ORGANIC DEBRIS, DURABLE, SOUND, FREE FROM DETRIMENTAL CRACKS, SEAMS, AND OTHER DEFECTS WHICH TEND TO INCREASE DETERIORATION FROM NATURAL CAUSES OR CAUSE BREAKAGE IN HANDLING OR PLACEMENT. ORGANICS, SAND, CLAY, CHERT AND ROCK FINES ARE PROHIBITED. THE STONE SHALL BE SELECTED GRANITE, QUARTZITE, RHYOLITE, OR LIMESTONE.
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- 6. THE CREST OF THE REVETMENT WILL SERVE AS A WALKABLE PASSAGE FOR EQUIPMENT AND PERSONNEL. VOIDS WILL BE FILLED WITH SMALL STONE.

REVETMENT WILL BE KEPT FREE OF VEGETATION (~5 FT) TO ALLOW SPACE/PASSAGE FOR CONSTRUCTION EQUIPMENT.

1. BARE AREAS ON THE UPPER BANK SLOPE WILL BE STABILIZED WITH

2. BEACH GRASS VEGETATION WILL BE PLANTED THROUGH HOLES IN THE

INDIGENOUS COASTAL WOODY VEGETATION WILL BE PLANTED ON THE

3. AFTER THE BEACH GRASS VEGETATION ACHIEVES A STABLE SLOPE,

4. THE STEEPER SLOPE AT THE TOP OF THE COASTAL BANK (I.E. THE

5. THE SLOPE IMMEDIATELY ABOVE THE TOP OF THE PROPOSED

TOP 10-15 FEET) WILL BE KEPT FREE OF PLANTINGS TO PROVIDE

GENERAL NOTES

- 1. ALL ELEVATIONS ARE BASED ON MEAN LOW WATER DATUM (M.L.W.=0.0').
- 2. FOR LOCATION OF SECTION F-F, SEE DWG. NO. 210019.1-3-08.

GRAPHIC SCALES CHECK GRAPHIC SCALES BEFORE USING

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SLOPE TREATMENT

JUTE FABRIC.

JUTE FABRIC PINNED TO THE BANK SURFACE.

NESTING HABITAT FOR BANK SWALLOWS.

	DESCRIPTION		DATE	BY	DESCRIPTION	DATE	BY	
S	1	REVISED SLOPE PROTECTION DESIGN	8/23/13	BRJ0				
REVISIONS	2	REVISED TOE DESIGN; ADDED RIPRAP NOTE 6	8/27/13	AZSL				
<u>R</u>								
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Consultants

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SCONSET BEACH PRESERVATION FUND


18 Sesapana Road, Nantucket, MA 02554

DRAWN BY: CAMA	NOTICE OF INTENT
CHECKED BY: AZSL	
QC REVIEW: JOMA	PROPOSED SECTION F-F AT LOT 79

return the drawing, all copies and all mat	erial copied the	erefrom.
SCONSET BLUFF EROSION CONTROL PROJECT NOTICE OF INTENT	SCALE 1/8"=1'-0" DATE 8/11/13	REVISION 2

210019.1-3-15


DRAWING NO.

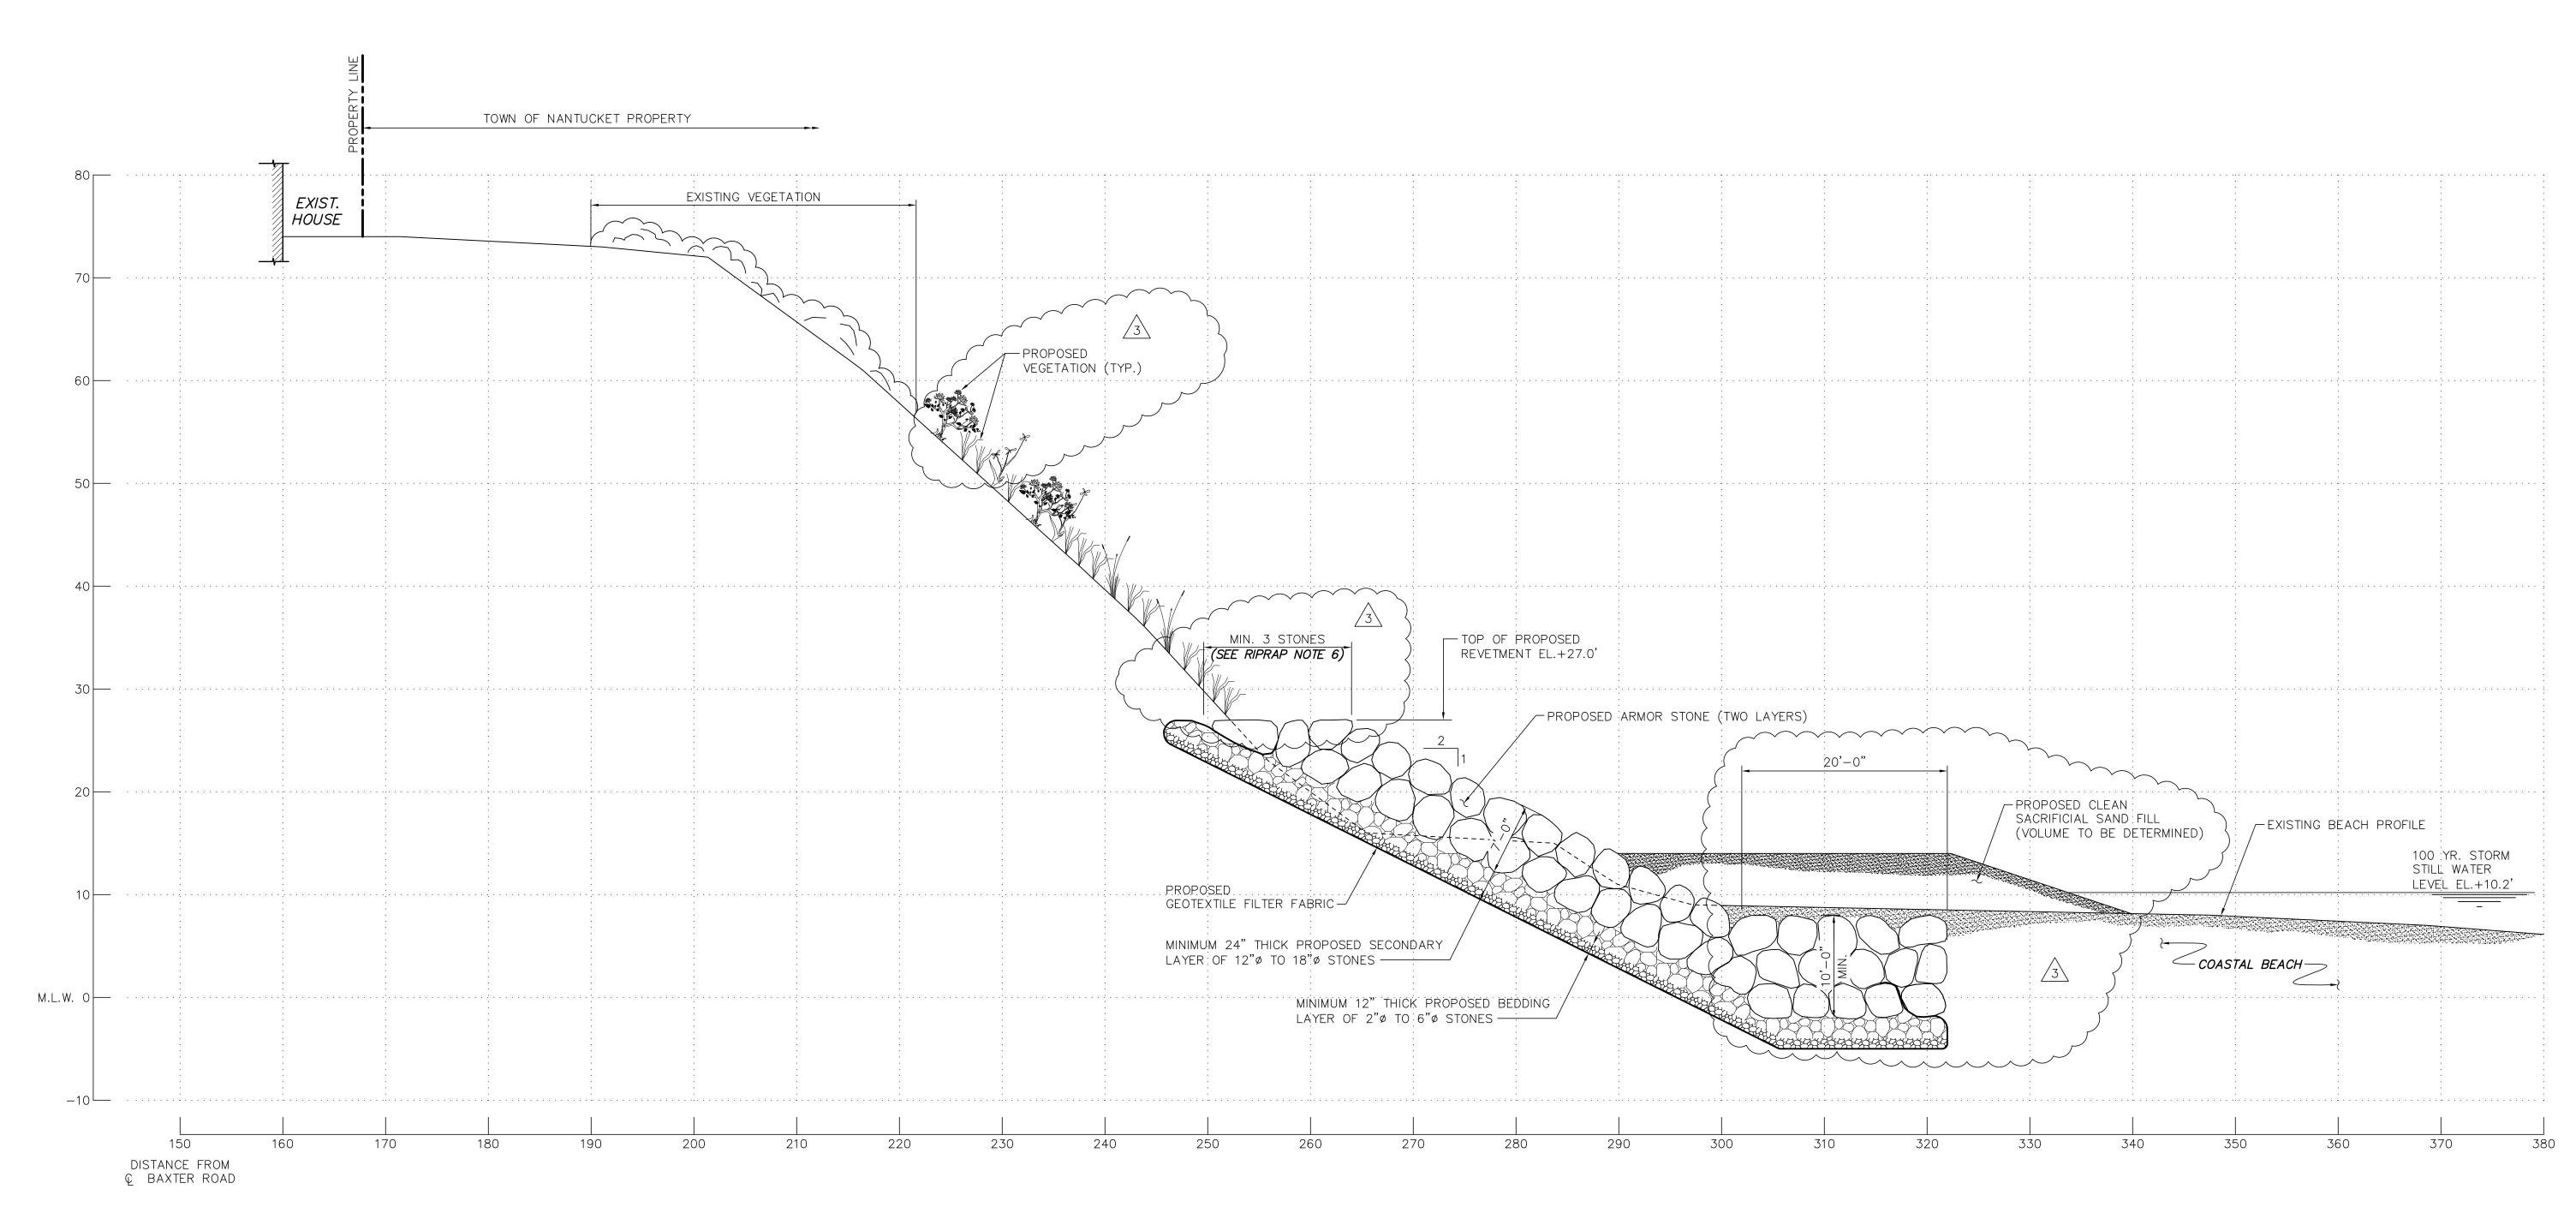

- 1. GEOTEXTILE FABRIC SHALL BE MIRAFI FILTERWEAVE FW-700 GEOTEXTILE FABRIC OR AN EQUIVALENT ACCEPTED BY THE ENGINEER OF RECORD.
- 2. INSTALL GEOTEXTILE FABRIC IN ACCORDANCE WITH MANUFACTURER'S RECOMMENDATIONS. MAINTAIN MINIMUM 12 INCH LAP AT ADJACENT SECTIONS.
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- 2. FILTER LAYER BEDDING STONE SHALL BE 12 TO 18 INCH DIAMETER NOMINAL CRUSHED STONE.
- 3. RIPRAP ARMOR STONE SHALL CONFORM TO THE FOLLOWING GRADATION:



 $\begin{array}{c} D_{MIN} = 3.0 \text{ FT} \\ D_{50} = 3.5 \text{ FT} \\ D_{MAX} = 4.5 \text{ FT} \end{array}$

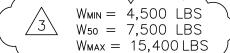- 4. ARMOR STONE SHALL HAVE A MINIMUM SIZE OF 36 INCHES MEASURING THE LEAST DIMENSION ACROSS ITS MIDSECTION.
- 5. STONES SHALL BE PLACED IN A MANNER TO PRODUCE A WELL GRADED MASS WITHOUT CAUSING DISPLACEMENT OF THE UNDERLYING MATERIAL. THE FINISHED SURFACE SHALL BE FREE FROM POCKETS OF SMALL STONES AND CLUSTERS OF LARGE STONES.

 6. THE CREST OF THE REVETMENT WILL SERVE AS A WALKABLE PASSAGE FOR EQUIPMENT AND PERSONNEL. VOIDS WILL BE FILLED WITH SMALL STONE.

FOR PERMITTING PURPOSES ONLY

1. BARE AREAS ON THE UPPER BANK SLOPE WILL BE STABILIZED WITH

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INDIGENOUS COASTAL WOODY VEGETATION WILL BE PLANTED ON THE

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4. THE STEEPER SLOPE AT THE TOP OF THE COASTAL BANK (I.E. THE

5. THE SLOPE IMMEDIATELY ABOVE THE TOP OF THE PROPOSED

SPACE/PASSAGE FOR CONSTRUCTION EQUIPMENT.

TOP 10-15 FEET) WILL BE KEPT FREE OF PLANTINGS TO PROVIDE

REVETMENT WILL BE KEPT FREE OF VEGETATION (~5 FT) TO ALLOW

SLOPE TREATMENT

JUTE FABRIC.

JUTE FABRIC PINNED TO THE BANK SURFACE.

NESTING HABITAT FOR BANK SWALLOWS.

GENERAL NOTES

- 1. ALL ELEVATIONS ARE BASED ON MEAN LOW WATER DATUM (M.L.W.=0.0').
- 2. FOR LOCATION OF SECTION G-G, SEE DWG. NO. 210019.1-3-09.

GRAPHIC SCALES

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DESCRIPTION DATE BY DESCRIPTION DATE BY 1 REVISED SECTION 8/14/13 BRJO 2 REVISED SLOPE PROTECTION DESIGN 8/23/13 BRJO

8/27/13 AZSL

REVISED TOE DESIGN; ADDED RIPRAP NOTE 6

Ocean and Coastal CCC COWI

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SCONSET BEACH PRESERVATION FUN

PRESERVATION FUND

18 Sesapana Road, Nantucket, MA 02554

DESIGNED BT: ADKA DRAWN BY: CAMA	SCONSET BLUFF EROSION CONTROL PROJECT NOTICE OF INTENT
CHECKED BY: AZSL	
QC REVIEW: JOMA	PROPOSED SECTION G-G AT LOT 65

DRAWING NO.

210019.1-3-16

/8"=1'-0"

DATE

110/OCC 2100191/3 Project Files/CAD/Task 3/10 dwa Dwa 16 Carrie I Wal